



OPERATIONS AND MAINTENANCE MANUALS

Regional Lagoons Manuals-ST56 Boonah STP-Sheds

Builder Thomas Coffey

> Compiled Feb 03, 2015



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Introduction

Introduction

This manual has been prepared by Ausfab for the purpose of Operation and maintenance of the Boonah portion of work of the Regional Lagoons Project. The work has been completed as per the Contract and Construction Drawings Supplied by Thomas Coffey.

Please find complete as-built Drawings in the Drawing Section of this manual.

The Following is a brief description of the scope of work.

- 1. Design and construction of the MF building.
- 2. Design and construction of the CO2 dosing building

Maintenance

Colorbond Maintenance

6 - Monthly

Simple maintenance of COLORBOND® steel and ZINCALUME® steel by regular washing with water, will not only enhance its life but maintain its attractiveness for longer periods thus protecting your asset. Applications where the paint finish is automatically washed by rainwater do not usually require this maintenance, e.g. roof cladding. Examples of applications requiring maintenance cleaning include wall cladding under eaves, garage doors and the underside of eave gutters.

Areas not regularly washed by rainwater should be hosed down at least every six months and more frequently in coastal areas where marine salt spray is prevalent, and in areas where high levels of industrial fallout occur.

In cases where the regular maintenance referred to above does not remove all dirt which may have adhered to the surface of the paint, the following procedure should be carried out:

Wash the surface with a mild solution of pure soap or mild non-abrasive kitchen detergent in warm water. Application should be with a sponge, soft cloth or soft bristle nylon brush, and should be gentle to prevent shiny spots.

The COLORBOND® steel and ZINCALUME® steel should be thoroughly rinsed with clean water immediately after cleaning to remove traces of detergent.

Never use abrasive or solvent type cleaners (turps, petrol, kerosene, paint thinners) on COLORBOND® steel and ZINCALUME® steel.

If cared for in accordance with these instructions, your building components made from COLORBOND® prepainted steel and ZINCALUME® steel will give many years of low maintenance life.

Leaf Beater Rainwater Head

1 - Monthly

The Clean Shield™ screen is mostly self cleaning. If cleaning is required simply lift the Clean Shield™ screen out by taking hold of

the quick release tabs and pull the Clean Shield™ screen upwards and outwards, then hose or brush off.

Operations & Tech Data

Leaf Beater - Rainwater head tech data

Linked Documents

Leaf_Beater_Original_Spec and Maintenance_Sheet.pdf

Colorbond steel

Linked Documents





Product Specifications



Products: Leaf Beater[®] Original with Clean Shield[™]

Code: RHLB01 – 90mm

RHLB02 - 100mm The Original Compact Rain Head - now with Enhanced Performance



Product Description

Keeps your Rain Harvesting system free of mosquitoes, vermin and debris.

The Leaf Beater® Original + Clean Shield™ is the practical and versatile Rain Head, featuring the new patented Clean Shield™ (single screen) technology. The Leaf Beater® Original + Clean Shield™ Rain Head prevents debris from entering the Rain Harvesting system, improves water quality and reduces tank maintenance. The single screen incorporates Clean Shield[™] technology which deflects leaves and debris away from the flow of water. This minimises maintenance and enhances catchment efficiency.

Features and Benefits

- Upgraded with new debris shedding single screen technology (Clean Shield™)
- Enhanced catchment efficiency
 - collect more rainwater
- Minimal maintenance
 - screen automatically sheds debris
- Higher flow rate performance

- Compact design suits smaller spaces
- A single mosquito proof stainless steel mesh screen with 0.955mm aperture
- Available in 90mm or 100mm outlet

Compliance

- Queensland Development Code MP 4.2
 - Water Saving Targets
- AS/NZS 3500.3:2003 Plumbing and Drainage
 - Stormwater Drainage
- HB230:2008 Rainwater Tank Design and Installation Handbook

- enHealth Council
 - Guidance on the Use of Rainwater Tanks
 - Preventing Mosquitoes Breeding
- Queensland Health Regulations 1996 (Part 8 - Mosquito Prevention)



COLORBOND® steel

Revision 13 December 2013

This literature supersedes all previous issues



Prepainted - PP

GENERAL DESCRIPTION

COLORBOND® prepainted steel, specifically designed by BlueScope Steel Limited to provide a high durability, premier cladding and roofing material for general use. To determine if warranties apply, please visit the BlueScope Steel website or contact BlueScope Steel Direct for advice.

TYPICAL USES

Roofing and accessories, wall cladding, rain water goods. For material selection advice, please contact BlueScope Steel Direct.

AUSTRALIAN STANDARDS

Substrate - AS 1397


Paint Coating - AS/NZS 2728 Type 3-4

PREFERRED SUBSTRATES

ZINCALUME® G550S AM100 steel with Activate™ technology

ZINCALUME® G300S AM100 steel with Activate™ technology{Refer Note 8}

Please refer to current price list or BlueScope Steel Limited State Sales Office for availability of colours and dimensions.

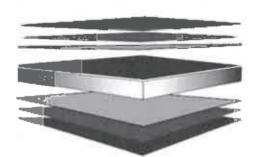

CORSTRIP® protective film may be available on request {Refer Note 3}

- Finish Coat (Finish Coat + Primer = nominal 25μm) (Refer Notes 4 & 5)
- Universal Comosion Inhibitive Primer
- Conversion Coating
- ZINCALUME®- Zinc/Aluminium alloy coated steel with Activate™ technology Substrate
- Conversion Coating
- Universal Corrosion Inhibitive Primer
- ← Backing Coat (Backing Coat + Primer = nominal 10μm total){Refer Note 6}

ATTRIBUTES TESTED DURING MANUFACTURE

Property	Test & Evaluation Method(s)	Results		
Adhotion				
Reverse Impact	AS/NZS 2728 (App. E)	≥10 joules		
T-bend	AS/NZS 2728 (App. F)	Maximum 6T. Refer Note 7.		
Hardness.				
Pencil	AS1580.405.1	HB or harder		
Specular gloss				
60º meter	AS/NZS 1580.602.2; ASTM D523 (test & eval)	Nominal ± 10 units		

Australia #800 800 789

COLORBONDS COLORBONDS Permagards, COLORBONDS Coglinax®, AQUAPLATES, CORSTRIBUS WHITEHAVEN'S RRITEWITES, DRUMSTOCKS and Blue Scope are made males of Blue Scope Steel Limites ABN 16 000 011 058

Please ensure you have the current data sheet for this product as displayed at steelproducts bluescopesteel com au



Q-Pulse Id TM\$1164 Active 15/05/2015

COLORBOND® steel

Revision 13 December 2013

This literature supersedes all previous issues



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PRODUCT ATTRIBUTES

Property	Test & Evaluation Method(s)	Results
Free hallon		
T-bend	ASTM D4145	Maximum 10T (no cracking) Refer Note 7
Recistance to abrasion		
Scratch	AS 2331 4 7 (test & eval)	Typically 2000g
And the stage		
Natural well washed exposure (10 yrs)	AS/NZS 1580 457 1	No flaking or peeling Refer Notes 9 & 10
Country influence and following the second		
Cleveland (500 hours)	ASTM D4545, AS/NZS 1580 481 1 9 (Blisters); AS1580 408 4 (Adhesion)	Blister density ≤3. Blister size ≤S2. No loss of adhesion or corrosion
the last that to convertible.		
Salt spray (1000 hours)	AS/NZS 2728 (App. I), ASTM B117, AS 2331 3 1, AS/NZS 1580 481 1 9 (Blisters), AS 1580 408 4 (Adhesion)	Blister density ≤2 Blister size ≤S3. Undercut from score ≤2mm. No loss of adhesion or corrosion. Refer Note 2.
Kesternich (SO2) (50 cycles)	DIN 50018	Edge creep <4mm Refer Note 2
Regionarie is enternational		
Natural well washed exposure (10 yrs)	AS/NZS 1580 457 1 & ASTM D2244 (Colour)	ΔE cielab 2000 Light colour ≤4 units, Intermediate colour ≤6 units, Dark colour. ≤10 units Refer Notes 9 & 10
QUV (2000 hours)	ASTM G154 & ASTM D2244 (Colour)	ΔE cielab 2000 Intermediate colour ≤5 units
Andheren in medicing		
Natural well washed exposure (10 yrs)	AS/NZS 1580 457 1 & AS/NZS 1580 481 1 11 (Chalk Method B)	Chalk rating ≤4. Refer Notes 9 & 10.
QUV (2000 hours)	ASTM G154 & AS/NZS 1580 481 1 11 (Chalk Method B)	Chalk rating ≤4
Hadinationer to Exclusive		the state of the s
Exposure	ASTM D1308 (3 1 1) & ASTM D2244 (Colour), AS/NZS 1580 481 1 9 (Blisters)	No discolouration or blistering Refei Notes 9 & 11
Research add		
Exposure	ASTM D1308 (3 1 1) & ASTM D2244 (Colour), AS/NZS 1580 481 1 9 (Blisters)	No discolouration or blistering. Refer Notes 2 & 11
Fig. Latterners, By alls of a		
Exposure	ASTM D1308 (3 1 1) & ASTM D2244 (Colour), AS/NZS 1580 481 1 9 (Blisters)	No discolouration or blistering Refer Notes 2 & 11
Part of the state		A
Exposure	AS/NZS 1530 3 (test & eval.)	Ignitability index: 0 rating in scale of 0-20 Spread of Flame index: 0 rating in scale of 0- 10 Heat evolved index: 0 rating in scale of 0- 10 Smoke evolved index: 0-1 rating in scale of 0-10
F 1 - 2-72 5 19 1921		
Exposure 100°C continuous (500 hrs)	ASTM D2244 (Colour)	Colour change ∆E cielab 2000 ≤3 units

Australia 1800 800 789

COLORBOND - COLORBOND - Permagaras - COLORBOND - Continava - AGUAPLATEE - DORSTRIPS - WHITEHAVEN * BRITEWITE* DRUMSTOCK® and BlueScope are hade marks of BlueScope Steel Limited ABN 18 000 011 058.

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COLORBOND® steel

Revision 13 December 2013

This literature supersades all previous issues



Prepainted - PP

IMPORTANT NOTES

- All warranties for a product, if any, are subject to eligibility. Terms and conditions apply. Nothing in this document is intended by BlueScope Steel to extend, modify or otherwise affect any stated product warranty. To find out more, please visit the BlueScope steel website or contact Steel Direct for advice.
- Product may not be suitable if it is intended to use COLORBOND® steel in an exterior application within 1km of salt marine locations, severe industrial or abnormally corrosive environments; in areas not washed by rain, or in applications where it will be wholly or partly buried in the ground. For selection of the most appropriate COLORBOND®steel product, please refer to Technical Bulletins TB1a, TB1b, CTB16, CTB21 and CTB22. Before purchase, you should check on suitability by visiting the BlueScope Steel website or by contacting BlueScope Steel Direct for advice.
- 3 The CORSTRIP® protective film should be removed from the painted steel strip immediately on installation. Sunlight can increase adhesion of the protective film to the painted surface if left uncovered outside.
- 4 Finish Coat the coating applied to the exposed surface of the prepainted coil which is expected to meet the Performance Requirements.
- 5 The product is supplied with a nominal 25 unit (60°) gloss Finish Coat
- Backing Coat- a thin coating applied to the reverse surface of the prepainted coil. It also gives additional durability to the reverse surface during the service life of the product, but for aesthetic reasons is not recommended for exposure to sunlight. Performance Requirements are generally not applicable to backing coats. Where specific Performance Requirements are deemed necessary for the reverse surface coating, a "double sided" product should be specified, in which case a topcoat of full nominal thickness will be applied.
- 7 The minimum internal bend diameters for forming processes to achieve no paint cracking (visible using x10 magnification) and to avoid paint adhesion issues are specified by the T-bend flexibility and T-bend adhesion results respectively- where 1T equals the total coated thickness (tct) in mm of the material. These results are based on testing at 20-25°C.
- 8 For most products, the metallurgical ageing process which is inherent in the paint stoving cycle will result in some loss of ductility compared with unpainted product. However, minimum strength levels designated by relevant standards will still be applicable.
- 9 Improper storage or use of non-approved roll-forming lubricants may cause brand transfer and paint blushing, and may adversely affect colour and long term durability. Product in coil or sheet pack form must be kept dry. If the coil or sheet pack becomes wet, it must be separated and dried (refer AS/NZS 2728 Appendix L, and also Technical Bulletin TB7). Contact Steel Direct to obtain advice on appropriate rollforming lubricants.
- 10 Values quoted are for panels exposed in accordance with AS/NZS 2728. Variations for in-situ performance may occur due to complexity of building design and location.
- 11 COLORBOND® steel has good resistance to accidental spillage of solvents such as methylated spirits, white spirit, mineral turpentine, toluene, trichloroethylene and dilute mineral acids and alkalis. However, all spillages should be immediately removed by water washing and drying.

Australia 1800 800 785

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Please ensure you have the current data sheet for this product as displayed at sheelproducts bluescopested com au






Product Specifications


Installation


Gutter Installation

- Remove the existing Gutter Outlet from the roof guttering system.
- 2. Hold the new Gutter Outlet #3 against the fascia and the bottom of the gutter where the new outlet hole is to be, then using the gutter outlet as a template, draw around the inside of the outlet to mark the underside of the gutter for the new hole and cut out with tin snips.
- 3. Refit the Gutter Outlet #3 to the main body #1 and place a small amount of sealant in the sealant groove in #3.
- 4. Remove the Clean Shield™ screen #2 whilst fitting the Leaf Beater® Original. Simply lift the Clean Shield™ screen out (figure 4) by taking hold of the quick release tabs (red) and pull them outwards and upwards.
- 5. Slide the Leaf Beater[®] Original up against the fascia and position the Outlet #3 over the gutter outlet hole. Fasten the unit to the fascia with two rivets or screws through the back of the body 1# and into the fascia.
- 6. Insert the Clean Shield™ screen #2 into the rain head at approx 45 degrees (figure 1) until the front rubber channel is nearly over the front lip of the body. TIP: Wetting the rubber seal will help the screen slide into place.
- Fix the front of the Clean Shield™ screen #2 into place (figure 2) by sliding the rubber channel (red) over the front lip (green) of the body.
- 8. Reaching towards the back of the screen push down on the plastic frame (figure 3) so that the rear edge (red) is below the lowest notch (green) and firmly against the back wall of the Leaf Beater® Original.
- The Leaf Beater® Original is now ready for connection to the downpipe. Do NOT glue the Leaf Beater® Original to the downpipe. SECURE with a screw for easy replacement.

NOTE: Where gutters are stretched out or out of square it may be necessary to rivet the Outlet #4 to the gutter. Take care to ensure the Outlet #4 is sealed to the gutter in all situations.

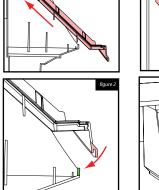

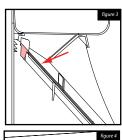

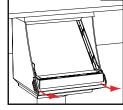

Mid-Mount Installation


To improve access for cleaning the Leaf Beater[®] Original Rain Head can be mounted down the wall at a convenient height.

It is important to note that when mid-mounting, the flow directional benefits of the rectangular gutter outlet supplied with the Leaf Beater® Original will be lost. However this is to be balanced with the benefits gained from easier access for maintenance

For mid-mounting, discard the top flow-directional gutter outlet. Cut the entry downpipe and install so that the downpipe sits approximately 5mm below the inside top edge of the Leaf Beater® Original body. This ensures the end of the pipe is within the Leaf Beater® Original and water is directed onto the face of the screen.

Recommondation: When mounting the Leaf Beater®
Original, make sure that it is mounted minimum of 1.2m
above the discharge point when pushing water underground
and then up into a tank. Long runs may require more than a
1.2m head depending on the pipe length and size of the pipe
and the volume required to be moved.



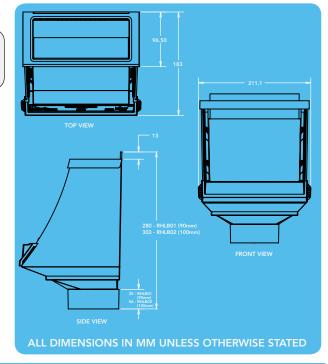

Maintenance

The Clean ShieldTM screen is mostly self cleaning. If cleaning is required simply lift the Clean ShieldTM screen out by taking hold of the quick release tabs and pull the Clean ShieldTM screen upwards and outwards, then hose or brush off.

DISCLAIMER This product specification is not a complete guide to product usage. Further information is available from Rain Harvesting Pty Ltd and from the Installation and Operating Instructions. This specification sheet must be read in conjunction with the Installation and Operating Instructions and all applicable statutory requirement. Product specifications may change without notice. © Rain Harvesting Pty Ltd



Warranties

Colorbond Warranty

Linked Documents



bslwarranty-RFG-CB-130607-0283- Boonah.pdf

AusFab Workmanship Warranty

Ausfab warrant their works from the date of practical completion for 12 months as per the terms and conditions of their contract with Thomas & Coffey.

Thomas & Coffey will warrant the works until the end of the defect liability period.

Certificates

Boonah - MF and Dosing Shed Slab Design Form 15

Linked Documents

Boonah - Shed Form 15.pdf

Boonah- MF Shed Form 16

Boonah- MF Shed Form 16

Linked Documents

Boonah MF Building- Form 16.pdf

Boonah pH Building- Form 16

Linked Documents

Boonah PH-Cl Building - Form 16.pdf

Boonah Pumping Station - Form 16

Linked Documents

Boonah Pump Station - Form 16.pdf

Boonah MF and Dosing Structure Design Form 15

Linked Documents

Shed Design- Form 15.pdf

Compliance Certificate for building Design or Specification

15

NOTE	This is to be used for the purposes of section 10 of the <i>Building Act</i> 1975 and/or section 46 of the <i>Building Regulation</i> 2006. RESTRICTION: A building certifier (class B) can only give a compliance certificate about whether building work complies with the BCA or a provision of the QDC. A building certifier (Class B) can not give a certificate regarding QDC boundary clearance and site cover provisions.
1. Property description This section need only be completed if details of street address and property description are applicable. EG. In the case of (standard/generic) pool design/shell manufacture and/or patio and carport systems this section may not be applicable. The description must identify all land the subject of the application. The lot & plan details (eg. SP / RP) are shown on title documents or a rates notice. If the plan is not registered by title, provide previous lot and plan details.	Street address (include no., street, suburb / locality & postcode) Gorkow Road BOONAH QLD Postcode 4310 Lot & plan details (attach list if necessary) Lot 1 & Lot 2 In which local government area is the land situated? Scenic Rim Regional Council
Description of component/s certified Clearly describe the extent of work covered by this certificate, e.g. all structural aspects of the steel roof beams.	Roof & Wall Framing, Wind Bracing, Tie-Down & Connections
3. Basis of certification Detail the basis for giving the certificate and the extent to which tests, specifications, rules, standards, codes of practice and other publications, were relied upon.	AS 1170.1, AS 1170.2, AS 4100, AS 4600 Structural Importance Level 3

LOCAL GOVERNME	NT USE ONLY		
			Approved form 15
Date received		Reference Number/s	Version 2 11/11

Form 15 continued	
4. Reference documentation Clearly identify any relevant documentation,	Drawing Nos: WK12-0541 / 1C, 2B
e.g. numbered structural engineering plans.	by Osborn Lane Consulting Engineers
5. Building certifier reference number	Building certifier reference number
6. Competent person details A competent person for building work, means a person who is assessed by the building certifier for the work as competent to practise in an aspect of the building and specification design, of the building work because of the individual's skill, experience and qualifications in the aspect. The competent person must also be registered or licensed under a law applying in the State to practice the aspect. If no relevant law requires the Individual to be licensed or registered to be able to give the	Name (in full) Robert K Lane Company name (if applicable) Osborn Lane Consulting Engineers Phone no. business hours O7 4660 3300 Email address warwick@osbornlane.com
help, the certifier must assess the individual as having appropriate experience, qualifications or skills to be able to give the help.	Postal address PO Box 495
If the chief executive issues any guidelines for assessing a competent person, the building certifier must use the guidelines when assessing the person.	Warwick Qld Postcode 4370 Licence or registration number (if applicable) RPEQ 4084
7. Signature of competent person This certificate must be signed by the individual assessed by the building certifier as competent.	Signature Date 08 th March 2013

The *Building Act 1975* is administered by the Department of Local Government and Planning



Inspection Certificate / Aspect Certificate / QBSA Licensee Aspect Certificate

16

NOTE	This form sections :	n is to be used for the p 32, 35B, 43, 44 and 47	ourposes of section 10(c) of the <i>Building Regulation</i>	and 239 of the Building Act 1975 and/or 2006.
1. Indicate the type of certificate	×	Inspection Certificate	for	
The stages of assessable building work are listed in section 24 of the <i>Building Regulation 2006</i> or as conditioned by the building certifier. An aspect of building work is part of a	□	Stage of building wo (indicate the stage) Aspect of building wo	rk (for single detached class 1a o	or class 10 building or structure)
stage (e.g. waterproofing).		(indicate the aspect)	STRUCTURAL AND ROO	DFING MF BUILDING
	QBSA Licensee Aspect Certificate Scope of the work Scope of the work covered by the licence class under the Queensland Building Services Authority Regulation 2003 for the aspect being certified, e.g. scope of work for a waterproofing licence is "installin waterproofing materials or systems for preventing moisture penetration". An aspect being certified may include "wet area sealing to showers".			
	THE SUPPLY AND INSTALL OF STRUCTURAL BEAMS AND ROOFING			
<i>b</i>				
-				
2. Property description	Street address (Include no., street, suburb / locality & postcode)			
The description must identify all land the subject of the application. The lot & plan details (eg. SP / RP) are	Boonah STP	- Gorkow Rd, Boonah		Postcode 4310
shown on title documents or a rates notice. If the plan is not registered by title, provide previous lot and plan details.	Lot & plan	details (Attach list if neces	ssary)	
And A section and	In which local government area is the land situated?			
		_		
3. Building/structure description	Building/str	ructure description		Class of building / structure
The second secon	CONTROL A	AND PROCESSING BUILDING	Til.	
		·····		
	/			
4. Description of component/s certified Clearly describe the extent of work covered by this certificate, e.g. all structural aspects of the steel roof beams.	BEAMS AND	DROOFING		
LOCAL GOVERNMENT USE ONLY		-1		\$ - water - 11
DATE RECEIVED			REFERENCE NUMBER/S	Approved form 10 Version 3, 11/11

Q-Pulse Id TM\$1164 Active 15/05/2015 Page 19 of 95

Form 16 continued 5. Basis of certification ALL DRAWINGS AND WORK COMPLETED IN ACCORDANCE WITH AS1428, AS1554, AS1100, AS4100 & AS/NZS 4680 Detail the basis for giving the certificate and the extent to which tests, specifications, rules, standards, codes of practice and other publications, were relied upon. 6. Reference documentation AS BUILT DRAWINGS ATTACHED Clearly identify any relevant documentation, e.g. numbered structural engineering plans. 7. Building certifier reference number Building certifier reference number Development approval number and development approval number 8. Building Certifier, competent person Name (in full) or QBSA licensee details NIGEL WEIS A competent person must be assessed as Contact person competent before carrying out the inspection. Company name if applicable The builder for the work cannot give a stage AUSFAB CONSTRUCTIONS NIGEL WEIS certificate of inspection. Phone no. business hours Mobile no. Fax no. A competent person is assessed by the building certifier for the work as competent to 1300 995 970 0438 502 072 1300 998 983 practice in an aspect of the building and specification design, because of the individual's Email address skill, experience and qualifications. The nigel.weis@ausfabconstructions.com.au competent person must be registered or licensed under a law applying in the State to Postal address practice the aspect. 40 KENILWORTH STREET WARWICK If no relevant law requires the individual to be licensed or registered, the certifier must assess Postcode the individual as having appropriate Licence number experience, qualifications or skills to be able to Licence class give the help. STRUCTURAL STEEL 1207479 If the chief executive issues any guidelines for Date approval to inspect received from building certifier assessing a competent person, the building certifier must use the guidelines when assessing the person. 9. Signature of building certifier, competent person or QBSA licensee Date Signature Note: A building certifier must sign this form for temporary swimming pool fencing under 26/06/2013

The Building Act 1975 is administered by the Department of Local Government and Planning



section 4 of Schedule 1 of QDC MP 3.4.

Inspection Certificate / Aspect Certificate / QBSA Licensee Aspect Certificate

16

NOTE	This form is to be used for the purpo sections 32, 35B, 43, 44 and 47 of the	oses of section 10(c) and 239 of the <i>Building Act 1975</i> and/or e <i>Building Regulation 200</i> 6.
1. Indicate the type of certificate	Inspection Certificate for	
The stages of assessable building work are listed in section 24 of the <i>Building Regulation 2006</i> or as conditioned by the building certifier. An aspect of building work is part of a stage (e.g. waterproofing).	Stage of building work (for (indicate the stage) Aspect of building work (indicate the aspect)	single detached class 1a or class 10 building or structure) STRUCTURAL AND ROOFING PH-CI BUILDING
	QBSA Licensee Aspect Scope of the work Scope of the work covered by the licence Regulation 2003 for the aspect being ce	t Certificate ce class under the Queensland Building Services Authority ertified, e.g. scope of work for a waterproofing licence is "installing preventing moisture penetration". An aspect being certified may
A-5-5-5-5-5-5-5-5-5-5-5-5-5-5-5-5-5-5-5	THE SUPPLY AND INSTALL OF STRUCTURAL BEA	MIS AND ROOFING
2. Property description	Street address (Include no., street, suburb	/ locality & postcode)
The description must identify all land the subject of the application. The lot & plan details (eg. SP / RP) are shown on title documents or a rates notice. If the plan is not registered by title, provide	Boonah STP - Gorkow Rd, Boonah Lot & plan details (Attach list if necessary)	Postcode 4310
previous lot and plan details.	In which local government area is the la	nd situated?
3. Building/structure description	Building/structure description	Class of building / structure
	CONTROL AND PROCESSING BUILDING	
4. Description of component/s certified Clearly describe the extent of work covered by this certificate, e.g. all structural aspects of the steel roof beams.	BEAMS AND ROOFING	
LOCAL GOVERNMENT USE ONLY		INCE NUMBERIS Approved form 16

Form 16 continued 5. Basis of certification ALL DRAWINGS AND WORK COMPLETED IN ACCORDANCE WITH AS1428, AS1554, AS1100, AS4100 & AS/NZS 4680 Detail the basis for giving the certificate and the extent to which tests, specifications, rules, standards, codes of practice and other publications, were relied upon. 6. Reference documentation AS BUILT DRAWINGS ATTACHED Clearly identify any relevant documentation, e.g. numbered structural engineering plans. 7. Building certifier reference number Building certifier reference number Development approval number and development approval number 8. Building Certifier, competent person Name (in full) or QBSA licensee details NIGEL WEIS A competent person must be assessed as competent before carrying out the inspection. Company name if applicable Contact person The builder for the work cannot give a stage AUSFAB CONSTRUCTIONS NIGEL WEIS certificate of inspection. Mobile no. Phone no. business hours Fax no. A competent person is assessed by the building certifier for the work as competent to 1300 995 970 0438 502 072 1300 998 983 practice in an aspect of the building and Email address specification design, because of the individual's skill, experience and qualifications. The nigel.weis@ausfabconstructions.com.au competent person must be registered or licensed under a law applying in the State to Postal address practice the aspect. 40 KENILWORTH STREET WARWICK If no relevant law requires the individual to be licensed or registered, the certifier must assess Postcode the individual as having appropriate Licence class Licence number experience, qualifications or skills to be able to give the help. STRUCTURAL STEEL 1207479 If the chief executive issues any guidelines for Date approval to inspect received from building certifier assessing a competent person, the building certifier must use the guidelines when assessing the person. 9. Signature of building certifier, competent person or QBSA licensee Date Signature Note: A building certifier must sign this form for temporary swimming pool fencing under 26/06/2013 section 4 of Schedule 1 of QDC MP 3.4.

The Building Act 1975 is administered by the Department of Local Government and Planning



Inspection Certificate / Aspect Certificate / QBSA Licensee Aspect Certificate

16

NOTE	This form is to be used for the purpose sections 32, 35B, 43, 44 and 47 of the B	s of section 10(c) and 239 of the <i>Building Act 1975</i> and/or uilding Regulation 2006.		
1. Indicate the type of certificate	Inspection Certificate for			
The stages of assessable building work are listed in section 24 of the <i>Building Regulation 2006</i> or as conditioned by the building certifier. An aspect of building work is part of a	(indicate the stage) Aspect of building work	gle detached class 1a or class 10 building or structure) STRUCTURAL AND ROOFING PUMP STATION		
stage (e.g. waterproofing).	(indicate the aspect)	THE HOST ME HO		
	QBSA Licensee Aspect Certificate Scope of the work Scope of the work covered by the licence class under the Queensland Building Services Authority Regulation 2003 for the aspect being certified, e.g. scope of work for a waterproofing licence is "installing waterproofing materials or systems for preventing moisture penetration". An aspect being certified may include "wet area sealing to showers".			
	THE SUPPLY AND INSTALL OF STRUCTURAL BEAMS	AND ROOFING		
3				
2. Property description The description must identify all land the	Street address (Include no., street, suburb / Io	cality & postcode)		
subject of the application. The lot & plan details (eg. SP / RP) are shown on title documents or a rates notice. If the plan is not registered by title, provide	Lot & plan details (Attach list if necessary)	Postcode 4310		
previous lot and plan details.	In which local government area is the land situated?			
	In which local government area is the rand s	Situateu :		
3. Building/structure description	Building/structure description	Class of building / structure		
3. Building/structure description	CONTROL AND PROCESSING BUILDING	Class of building / structure		
4. Description of component/s certified Clearly describe the extent of work covered by this certificate, e.g. all structural aspects of the steel roof beams.	BEAMS AND ROOFING			
LOCAL GOVERNMENT USE ONLY				
DATE RECEIVED	REFERENCE	NUMBER/S Approved form 18 Version 3, 11/11		

romi to continued				
5. Basis of certification Detail the basis for giving the certificate and the extent to which tests, specifications, rules, standards, codes of practice and other publications, were relied upon.	ALL DRAWINGS AND WORK COMPL	ETED IN ACCORDANCE V	WITH AS1428, AS155	4, AS1100, AS4100 & AS/NZS 4680
publications, were relied upon.				
6. Reference documentation Clearly identify any relevant documentation, e.g. numbered structural engineering plans.	AS BUILT DRAWINGS ATTACHED			
7. Building certifier reference number and development approval number	Building certifier reference num	nber	Development a	approval number
8. Building Certifier, competent person or QBSA licensee details	Name (in full)			
A competent person must be assessed as competent before carrying out the inspection.	Company name if applicable Contact person AUSFAB CONSTRUCTIONS NIGEL WEIS			
The builder for the work cannot give a stage				
certificate of inspection.	Phone no. business hours	Mobile no.		Fax no.
A competent person is assessed by the building certifier for the work as competent to	1300 995 970	0438 502 072		1300 998 983
practice in an aspect of the building and specification design, because of the individual's	Email address			
skill, experience and qualifications. The competent person must be registered or	nigel.weis@ausfabconstructions.com.au			
icensed under a law applying in the State to	Postal address			
practice the aspect. If no relevant law requires the individual to be	40 KENILWORTH STREET WARWICK			
censed or registered, the certifier must assess ne individual as having appropriate		2000		Postcode 4370
xperience, qualifications or skills to be able to	Licence class		Licence numbe	r
give the help.	STRUCTURAL STEEL 1207479			
f the chief executive issues any guidelines for assessing a competent person, the building sertifier must use the guidelines when assessing the person.	Date approval to inspect receive	ed from building cert	ifier .	
3. Signature of building certifier, competent person or QBSA licensee			12	
Note: A building certifier must sign this form for temporary swimming pool fencing under section 4 of Schedule 1 of QDC MP 3.4.	Signature		Da	26/06/2013

The Building Act 1975 is administered by the Department of Local Government and Planning



Compliance Certificate for building Design or Specification

15

This is to be used for the purposes of section 10 of the <i>Building Act</i> 1975 and/or section 46 of <i>Building Regulation</i> 2006.		
RESTRICTION: A building certifier (class B) can only give a compliance certificate about whether building work complies with the BCA or a provision of the QDC. A building certifier (Class B) can not give a certificate regarding QDC boundary clearance and site cover provisions.		
Street address (include no., street, suburb / locality & postcode) Wind Region B, TC 2 & 3		
Postcode		
Lot & plan details (attach list if necessary)		
In which local government area is the land situated?		
Roof & Wall Framing, Wind Bracing, Tie-Down & Connections		
AS 1170.1, AS 1170.2, AS 4100, AS 4600		
Structural Importance Level 3		

LOCAL GOVERNMENT USE ONLY

Form 15 continued

4. Reference documentation Clearly identify any relevant documentation, e.g. numbered structural engineering plans.	Drawing Nos: WK12-0541 / 1			
5. Building certifier reference number	Building certifier reference numbe	r		
6. Competent person details A competent person for building work, means a person who is assessed by the building certifier for the work as competent to practise in an aspect of the building and specification design, of the building work because of the individual's skill, experience and qualifications in the aspect. The competent person must also be registered or licensed under a law applying in the State to practice the aspect. If no relevant law requires the individual to be licensed or registered to be able to give the help, the certifier must assess the individual as having appropriate experience, qualifications or skills to be able to give the help. If the chief executive issues any guidelines for assessing a competent person, the building certifier must use the guidelines when assessing the person.	Name (in full) Robert K Lane Company name (if applicable) Osborn Lane Consulting Engire Phone no. business hours 07 4660 3300 Email address warwick@osbornlane.com Postal address PO Box 495 Warwick Qld Licence or registration number (if a RPEQ 4084)	Mobile no. 0417 644 039	0'	x no. 7 4660 3310
7. Signature of competent person This certificate must be signed by the individual assessed by the building certifier as competent.	Signature		Date 07 th Ja	anuary 2013

The *Building Act 1975* is administered by the Department of Local Government and Planning



Help & Contact

AusFab Constructions

Trade or Product: Shed Design and Construction

Contact & Address Details:

Steve Bartlett | Procurement/ Project supervisor

Postal: PO Box 3558, Tingalpa QLD 4173

Production & Delivery: 40 Kenilworth Street, Warwick QLD 4370

P: 1300 995 970 |F: 1300 998 983 | 0437 930 343 | E: steve@ausfabconstructions.com.au

As Built Drawings

MF/ Dosing Building Framing Plan

Site: (ST056) Boonah

Linked Documents

WK12-0541 1D.pdf

Boonah MF Shed Shop Drawing As-built

Site: (ST056) Boonah

Linked Documents

Boonah MF Building As-built.pdf

Boonah Dosing Building Shop Drawing As-built

Site: (ST056) Boonah

Linked Documents

Boonah Dosing Building As-built.pdf

Boonah Pumping Station Shop Drawing As-built

Site: (ST056) Boonah

Linked Documents


Boonah Pump Station As-built.pdf

Boonah MF and Dosing Building Slab Design

Site: (ST056) Boonah


Linked Documents

12687-S4 - Boonah MF and Dosing slab.pdf

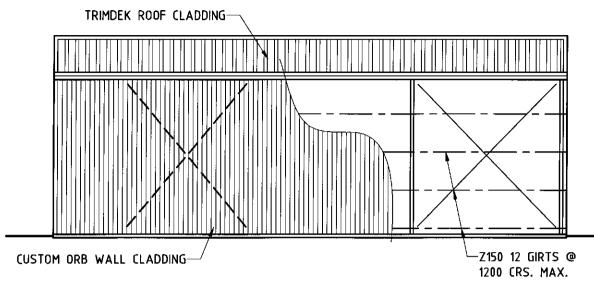


REAR ELEVATION


SCALE 1:100

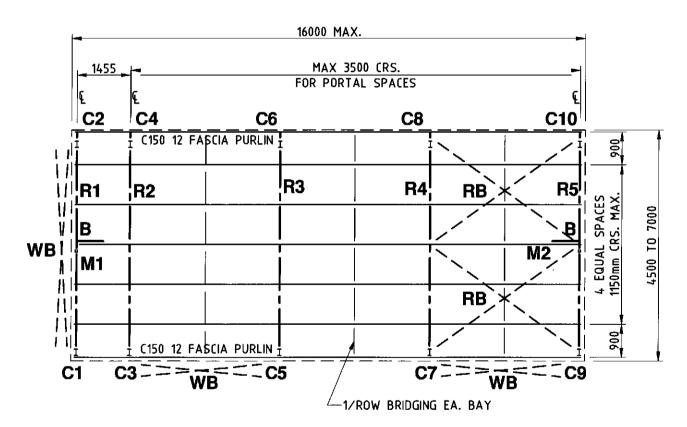

ROOF FRAMING PLAN

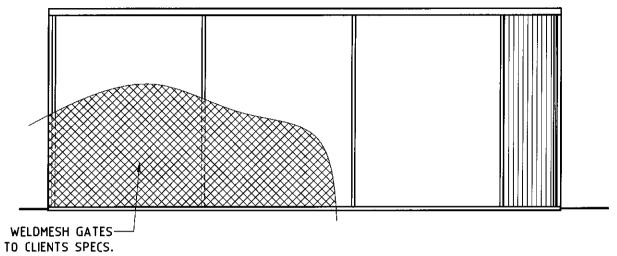

FRONT ELEVATION

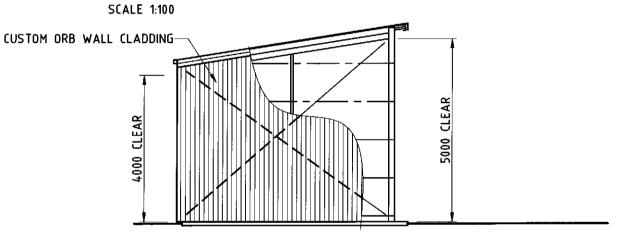

SIDE ELEVATION (TYPICAL) SCALE 1:100

MEMBER SCHEDULE								
COLUMNS	(C1 - C10)	- 150 UB 18 (4500-6000) - 180 UB 16 (7000)						
RAFTERS	(R1 - R5)	- 150 UB 18 (4500-6000) - 180 UB 16 (7000)						
MULLIONS	(M1 - M2)	- 65x65x4.0 S.H.S. (NOT REQUIRED ON 3000)						
PURLINS		- Z150 12 (CONTINUOUS)						
ROOF BRACE	(RB)	- R12 ROD SET MADE TAUT WITH TURNBUCKLES						
WALL BRACE	(WB)	- R12 ROD SET MADE TAUT WITH TURNBUCKLES						
END WALL BRACE	(B)	(REFER DETAIL - 1 PER END WALL)						

STEELWORK NOTES

- All work to be in accordance with current SAA codes and the Building Code of Australia.
- 2. Builder to verify all information and dimensions on site prior to commencement of construction.
- 3. Unless noted otherwise: Bolts to be M12 8.8/S. All fin, gusset & end plates to be 8 plate. Welds to be 6mm C.F.W. to mild steel and 3mm C.F.W. to cold-rolled steel.
- 4. Maintain stability of structure throughout erection.
- All steel work to be power brushed & painted with two coats of red zinc oxide primer or hot dipped galvanized.
- 6. Design Wind Speed 54 m/s
- 7. Structural Importance Level 3

<u>Note</u>	1.	Bu	ilder	to	ve	rify	all	infor	matic	n 8	Ŗ.	dimensi	ons
		on	site	pri	10	to	comi	nence	ment	of	C	onstruc	tion

- 2. DO NOT SCALE DRAWINGS
- 3. This drawing and the copyright thereof remains the property of **OSBORN LANE** Consulting Engineers A.B.N. 51 132 296 754


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rs i	Issued	4/12/2012	Α							
	Revised members	17/12/2012	В							
	Revised wind speed	18/12/2012	C							


OSBORN CONSULTING ENGINEERS


(Head Office) 148A Palmerin St. 2: Warwick Qid. 4370 |ph Ph 07 4660 3300 |Ph Fax 07 4660 3310 |FG


25 Warwick Road Ipswich Qid. 4305 Ph 07 3282 7770 Fox 07 3281 7237 Fox 07 3876 3045 PROPOSED BUILDING FRAME TO DRAWING Nos. 5348-HD 1001 FOR AUSFAB CONSTRUCTIONS


ROOF FRAMING PLAN						
drawn:	C.F.P.	checked: C.F.R.	rev:			
checked:		RPEQ. 4084	D			
scale: A	s Shown	job no.:	dwg no			
SHEET	1 of 2	WK12-0541	-1			

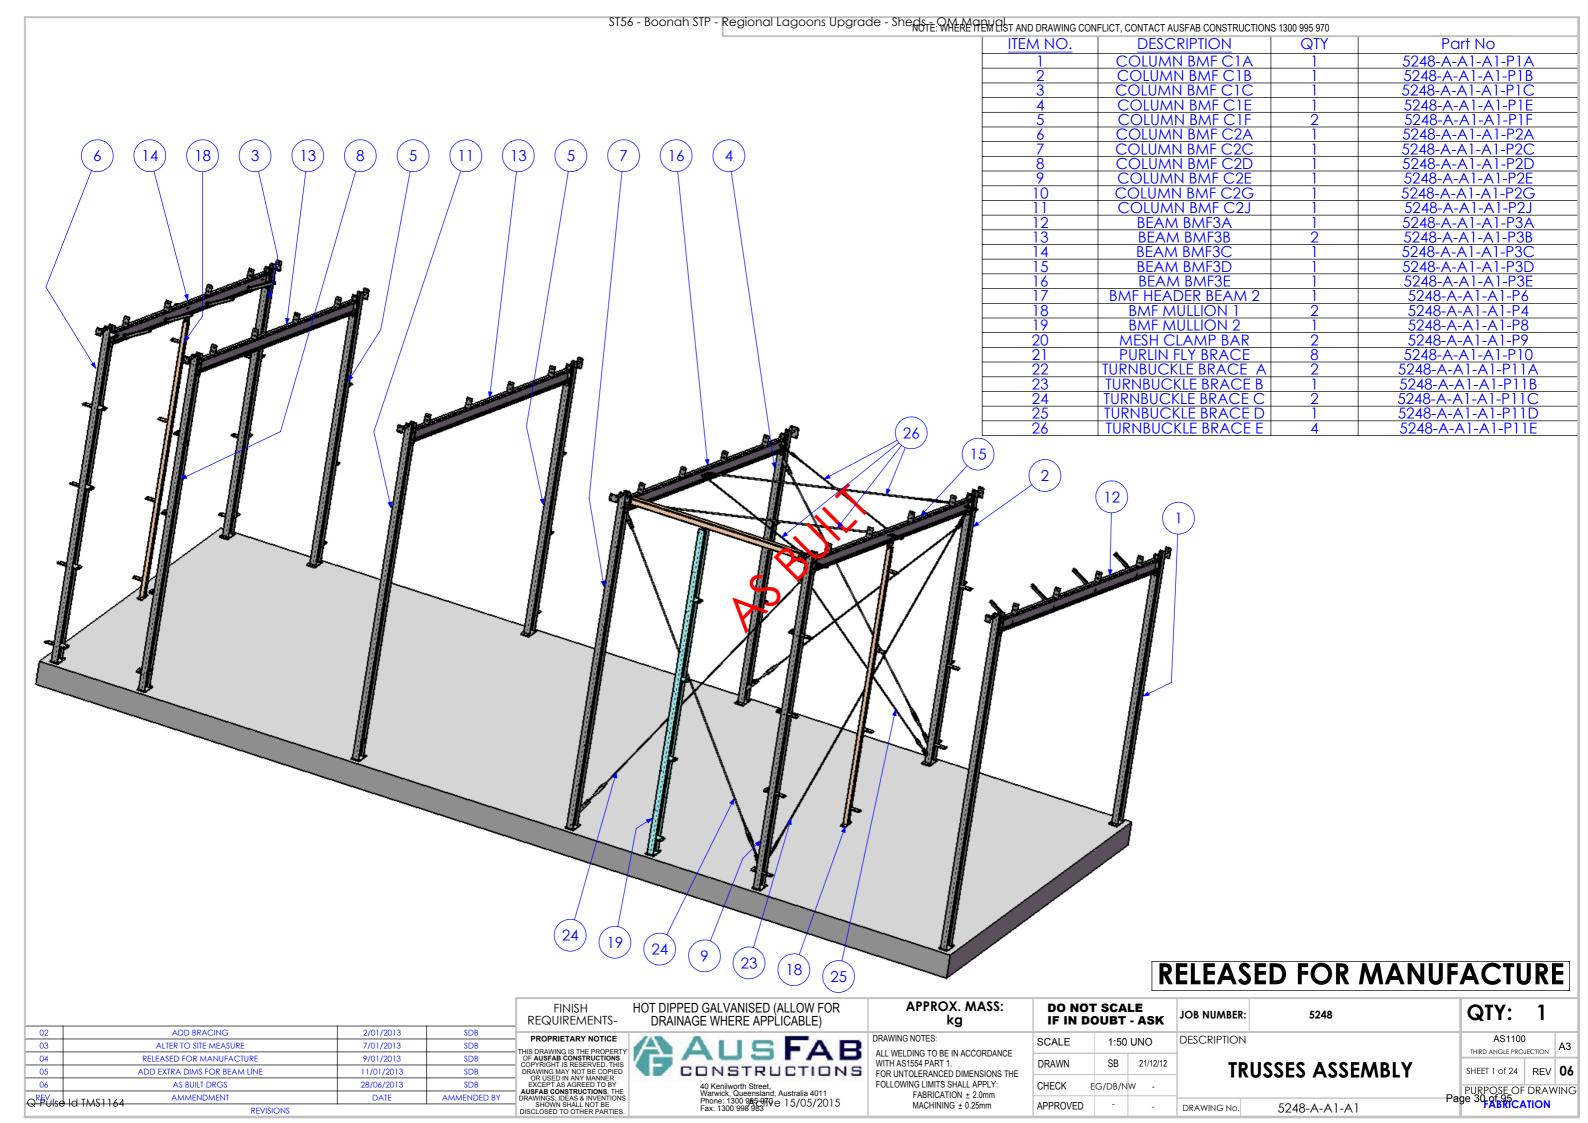


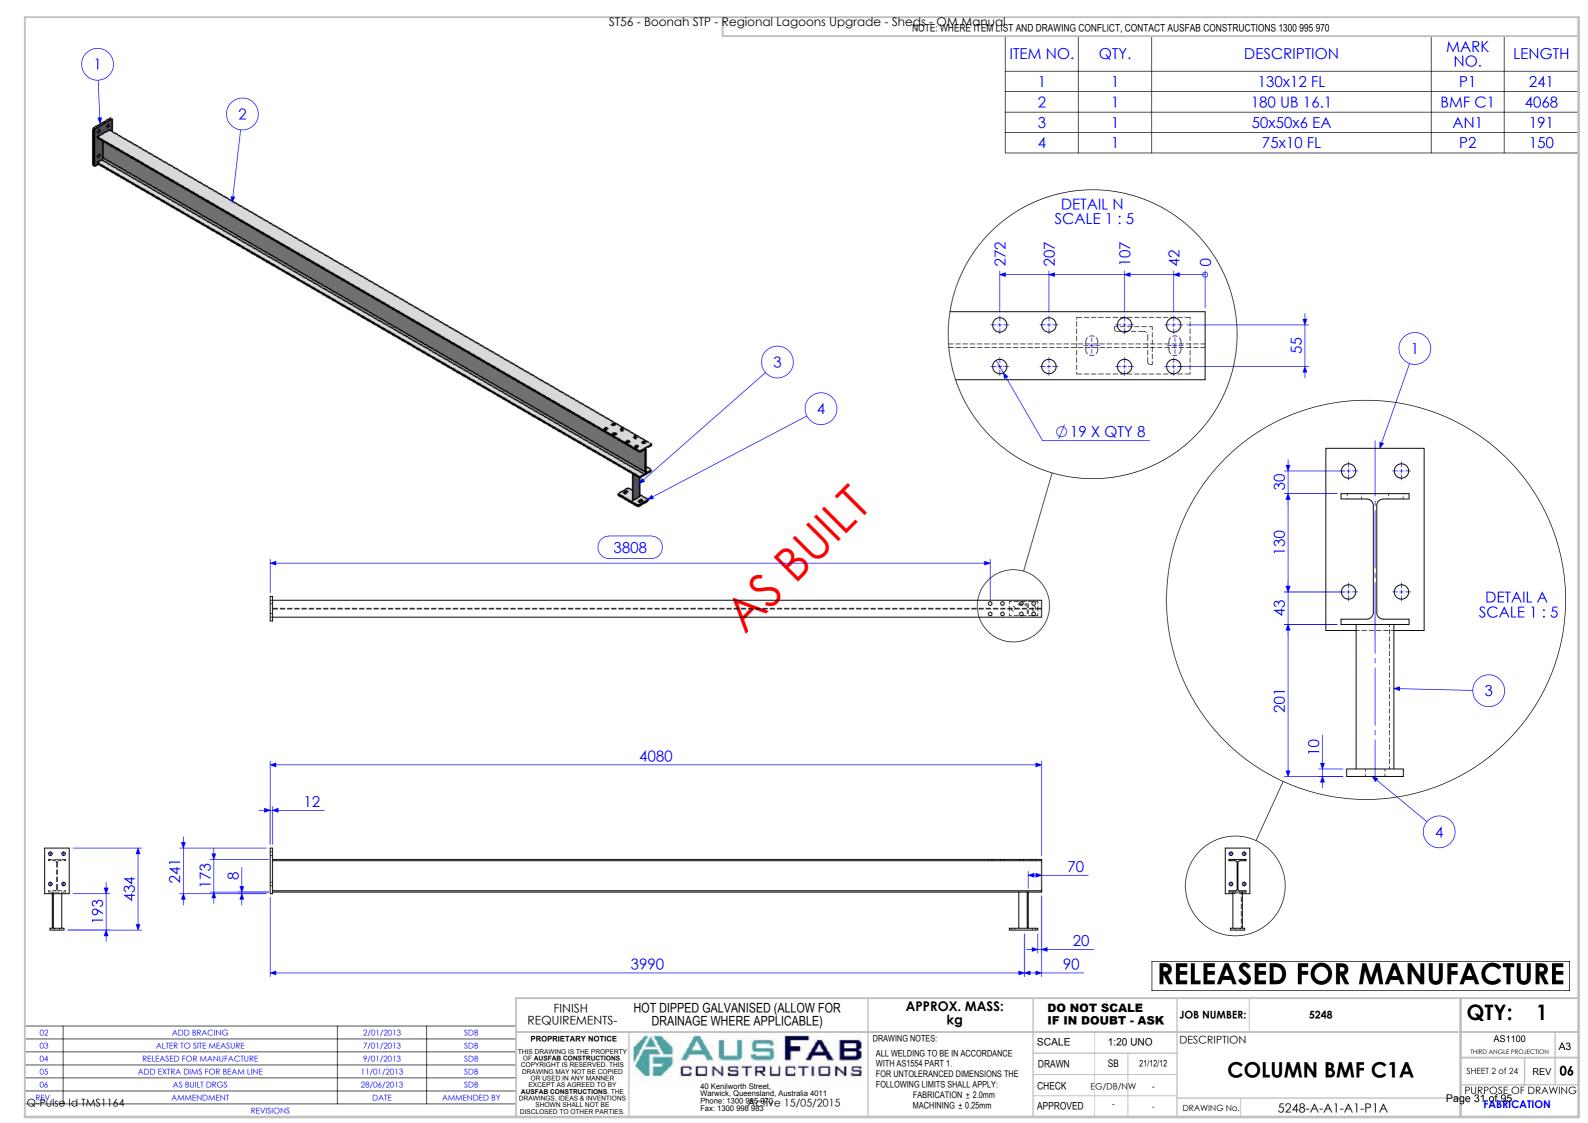


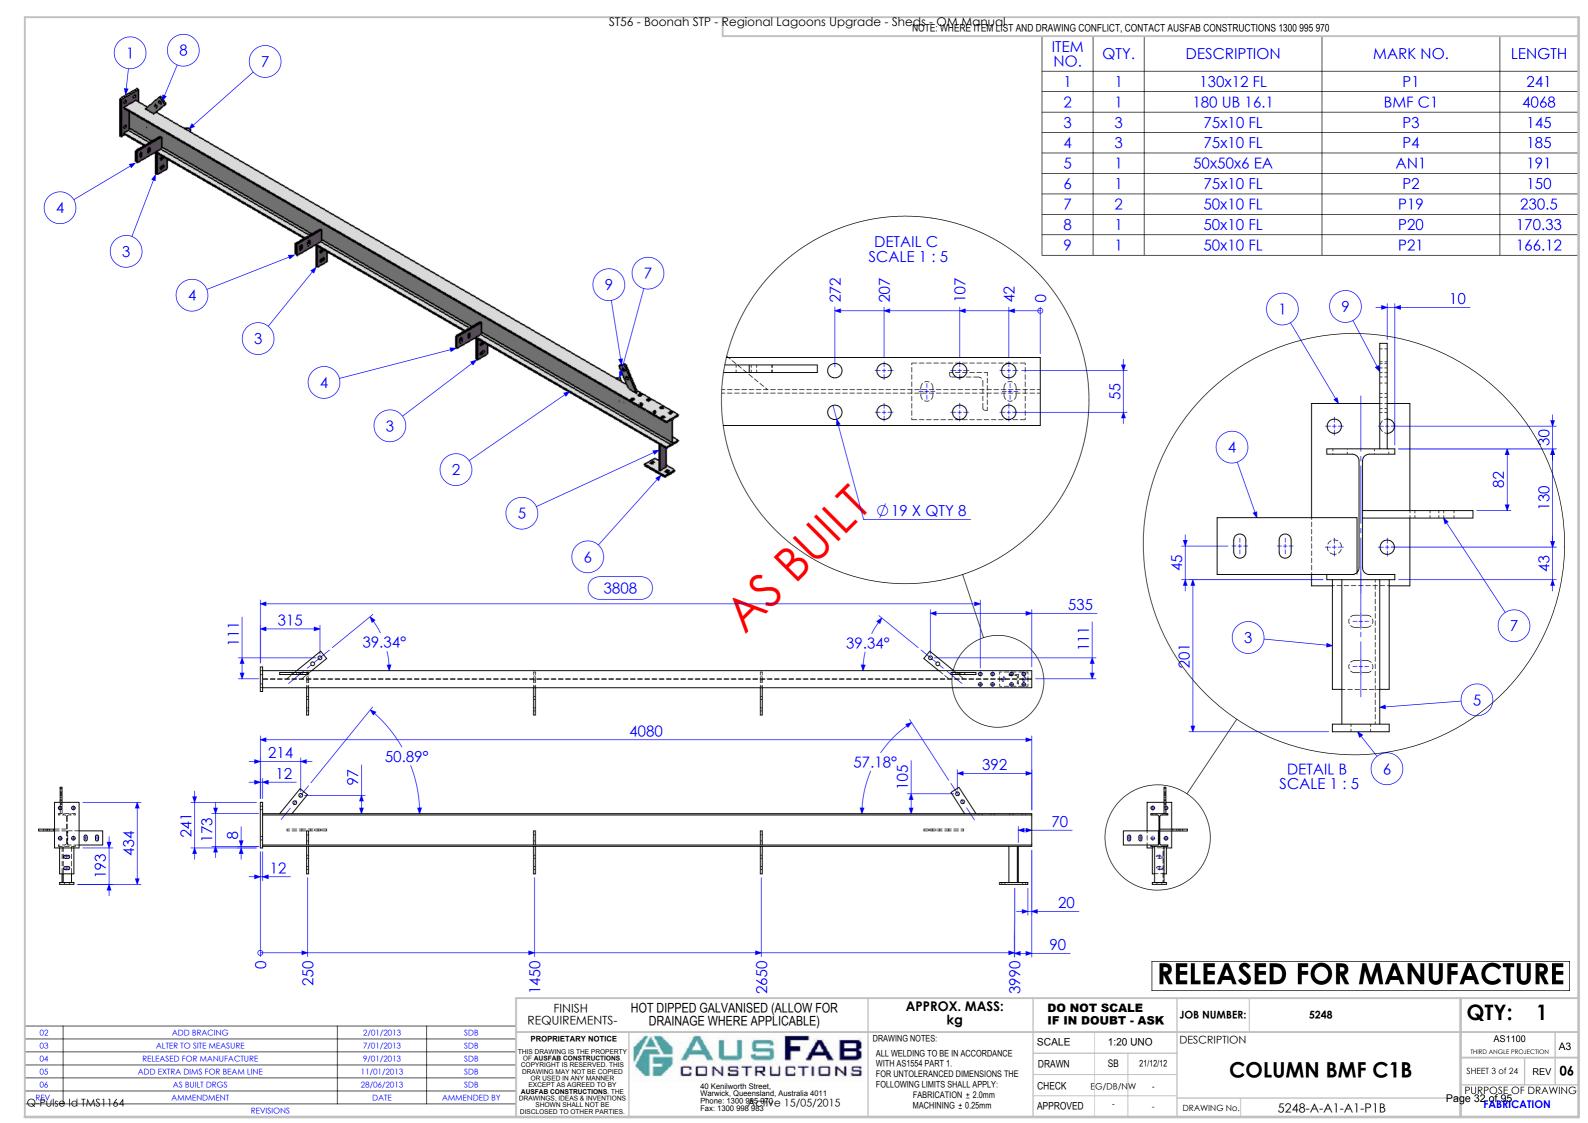


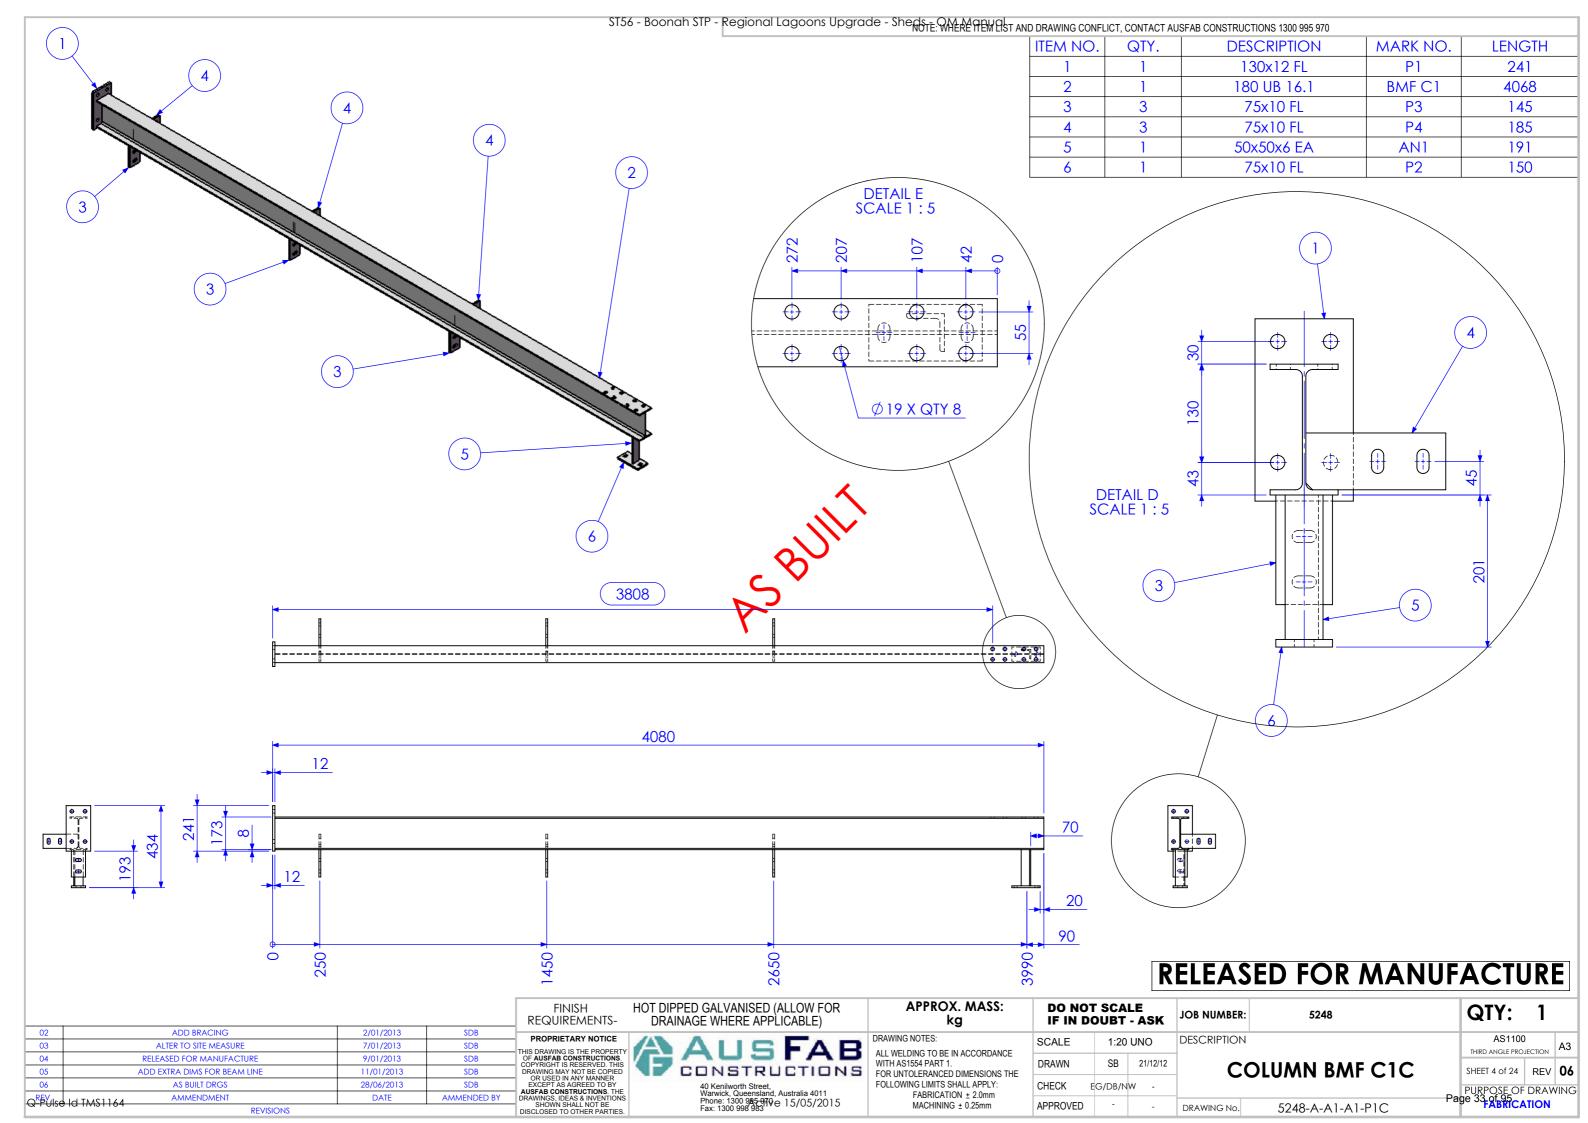


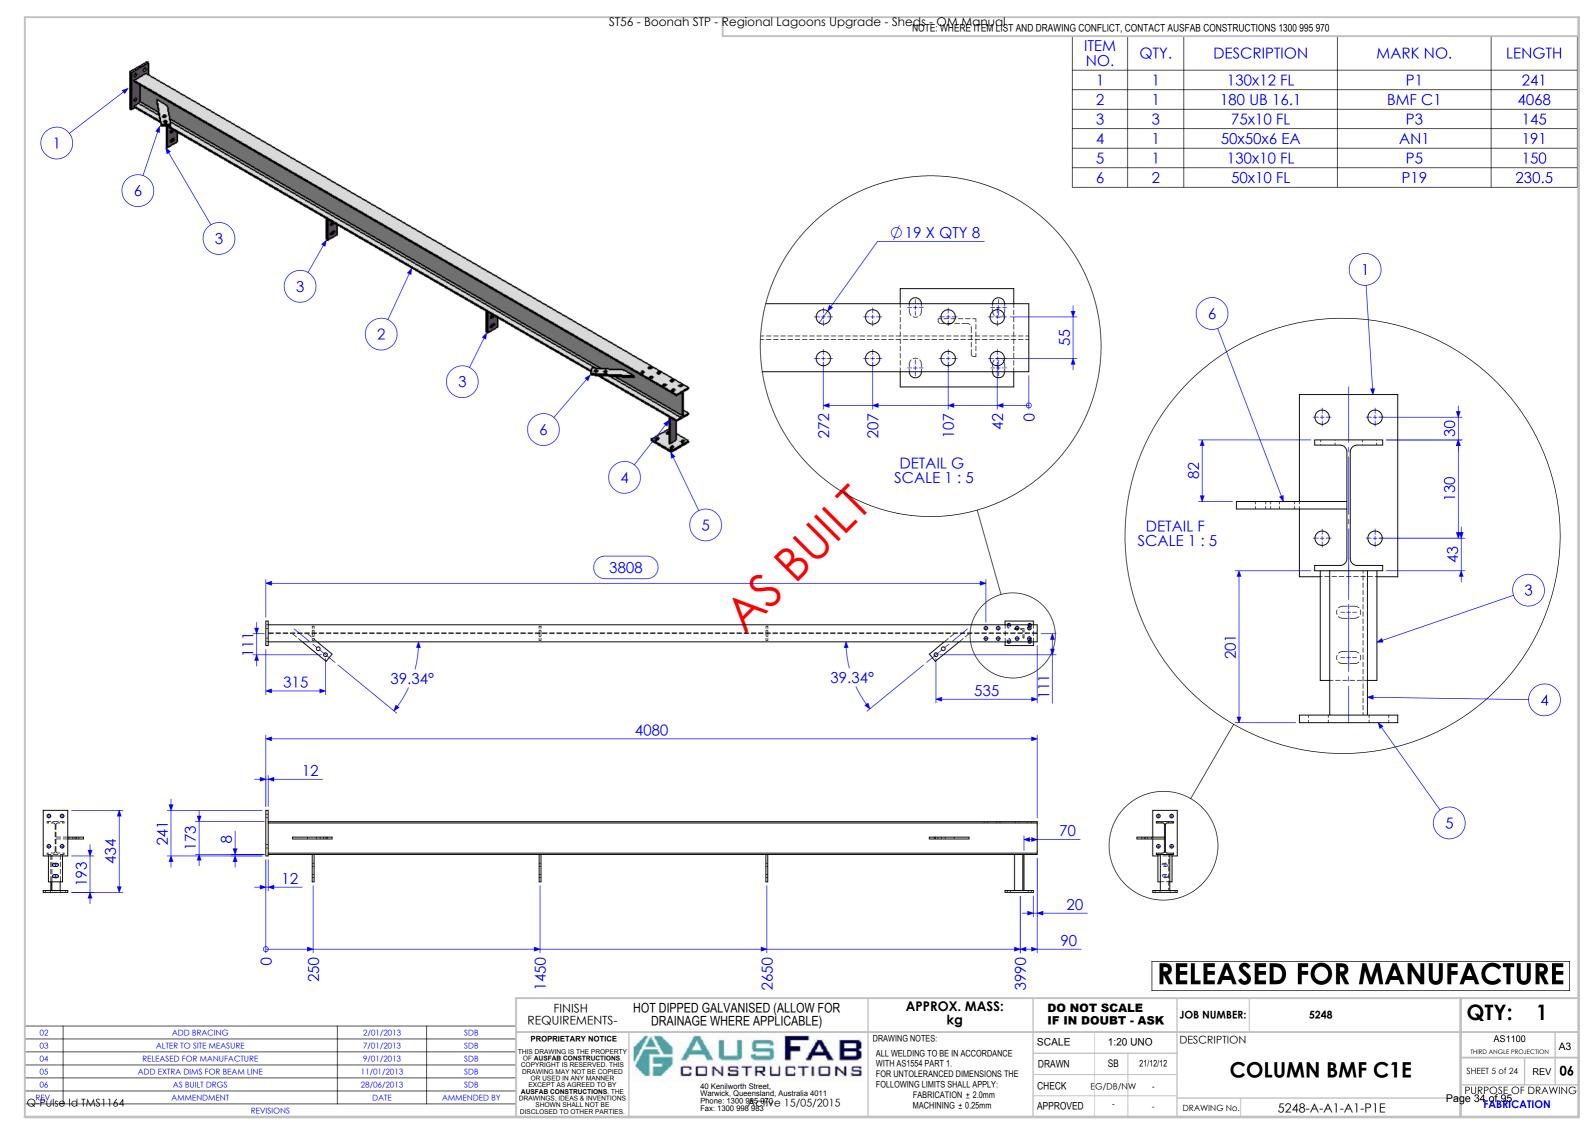


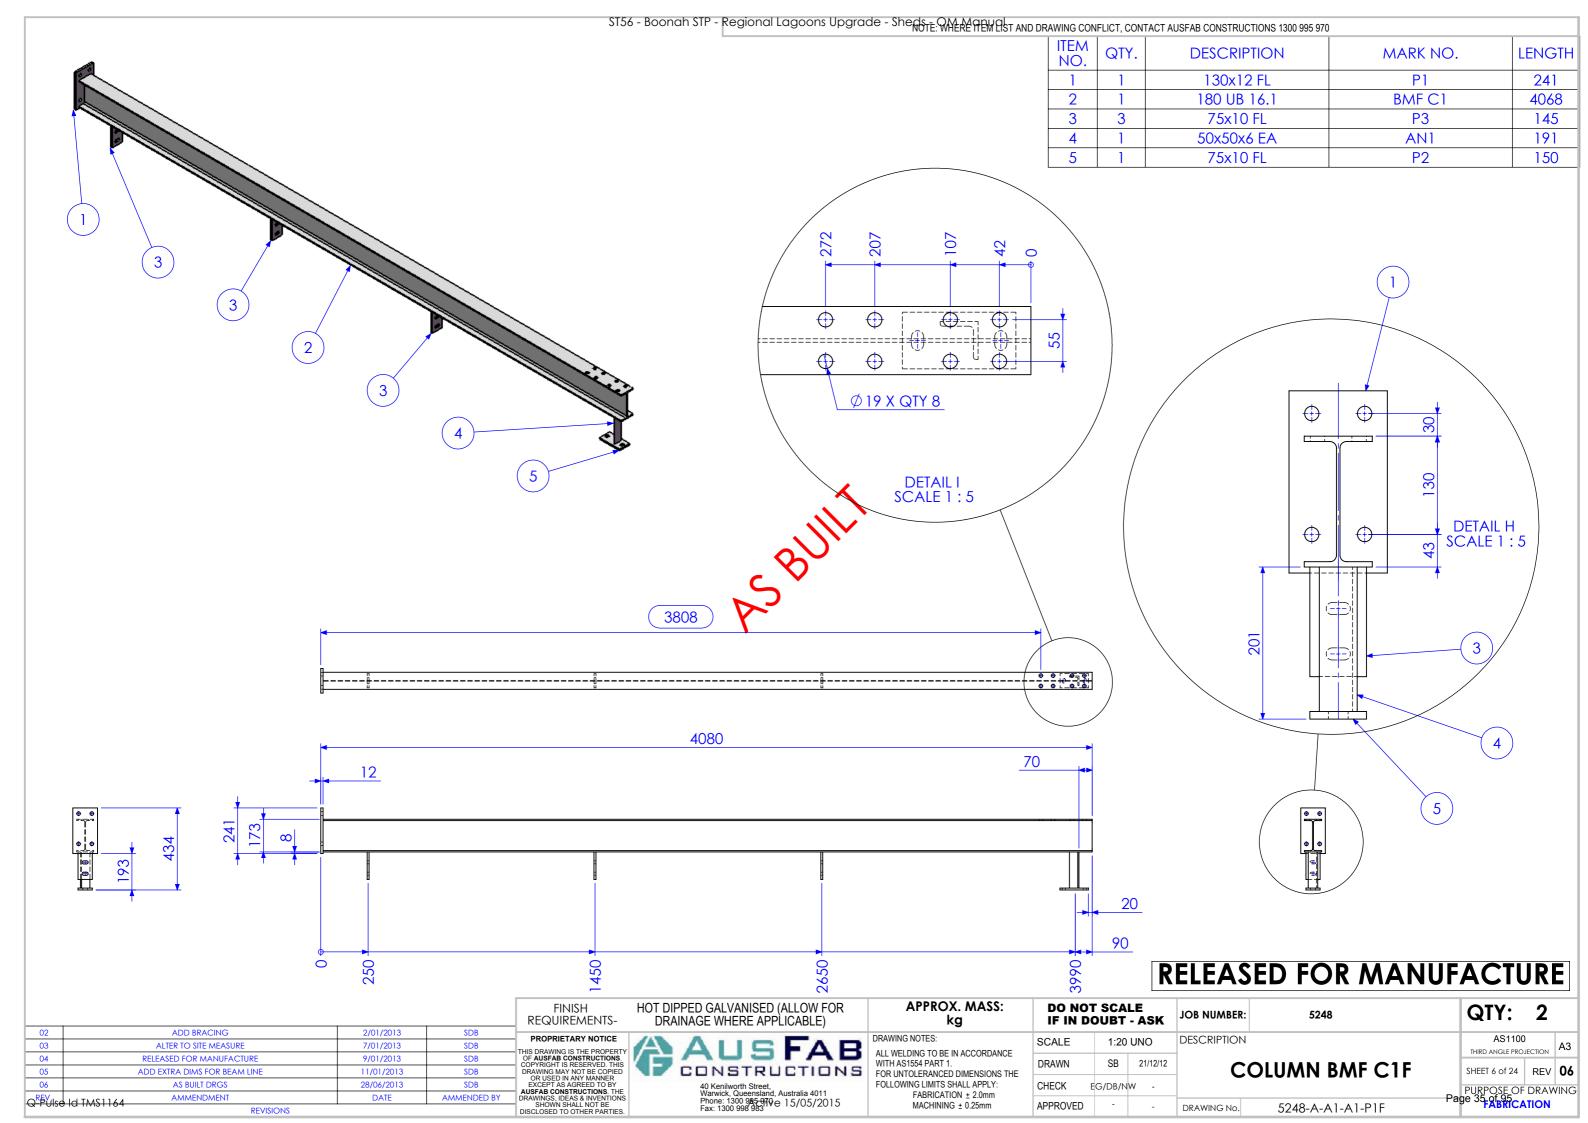


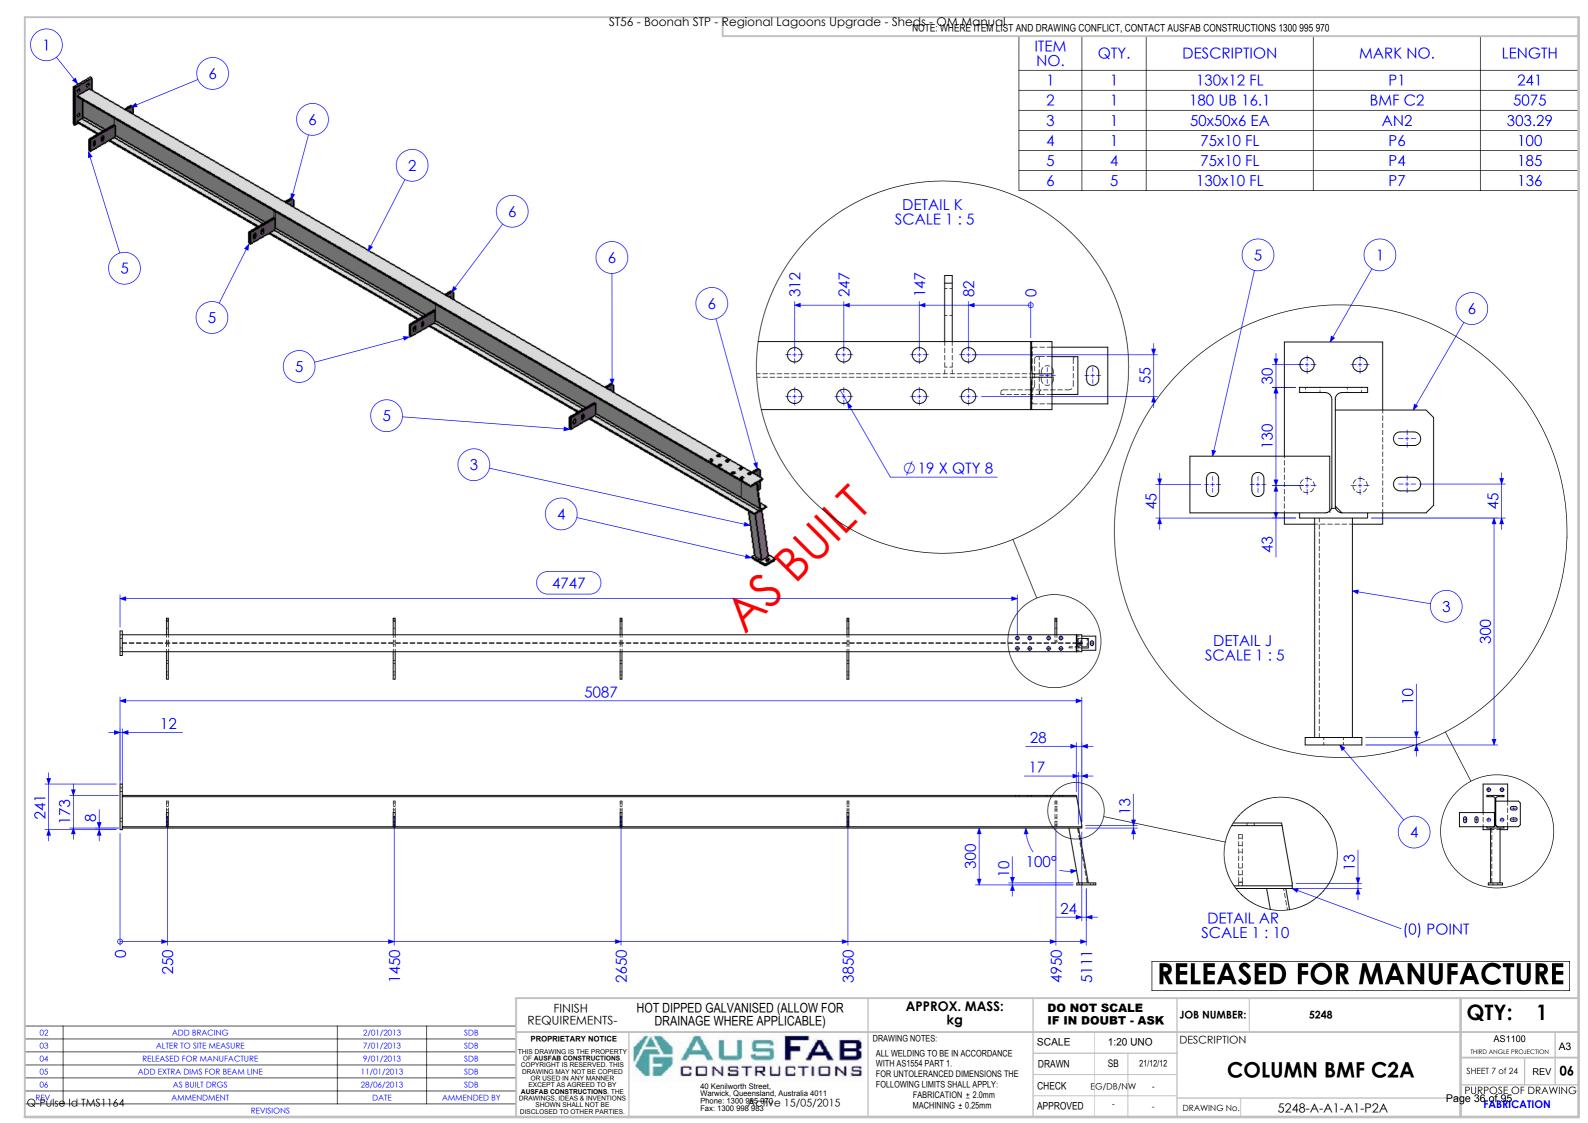


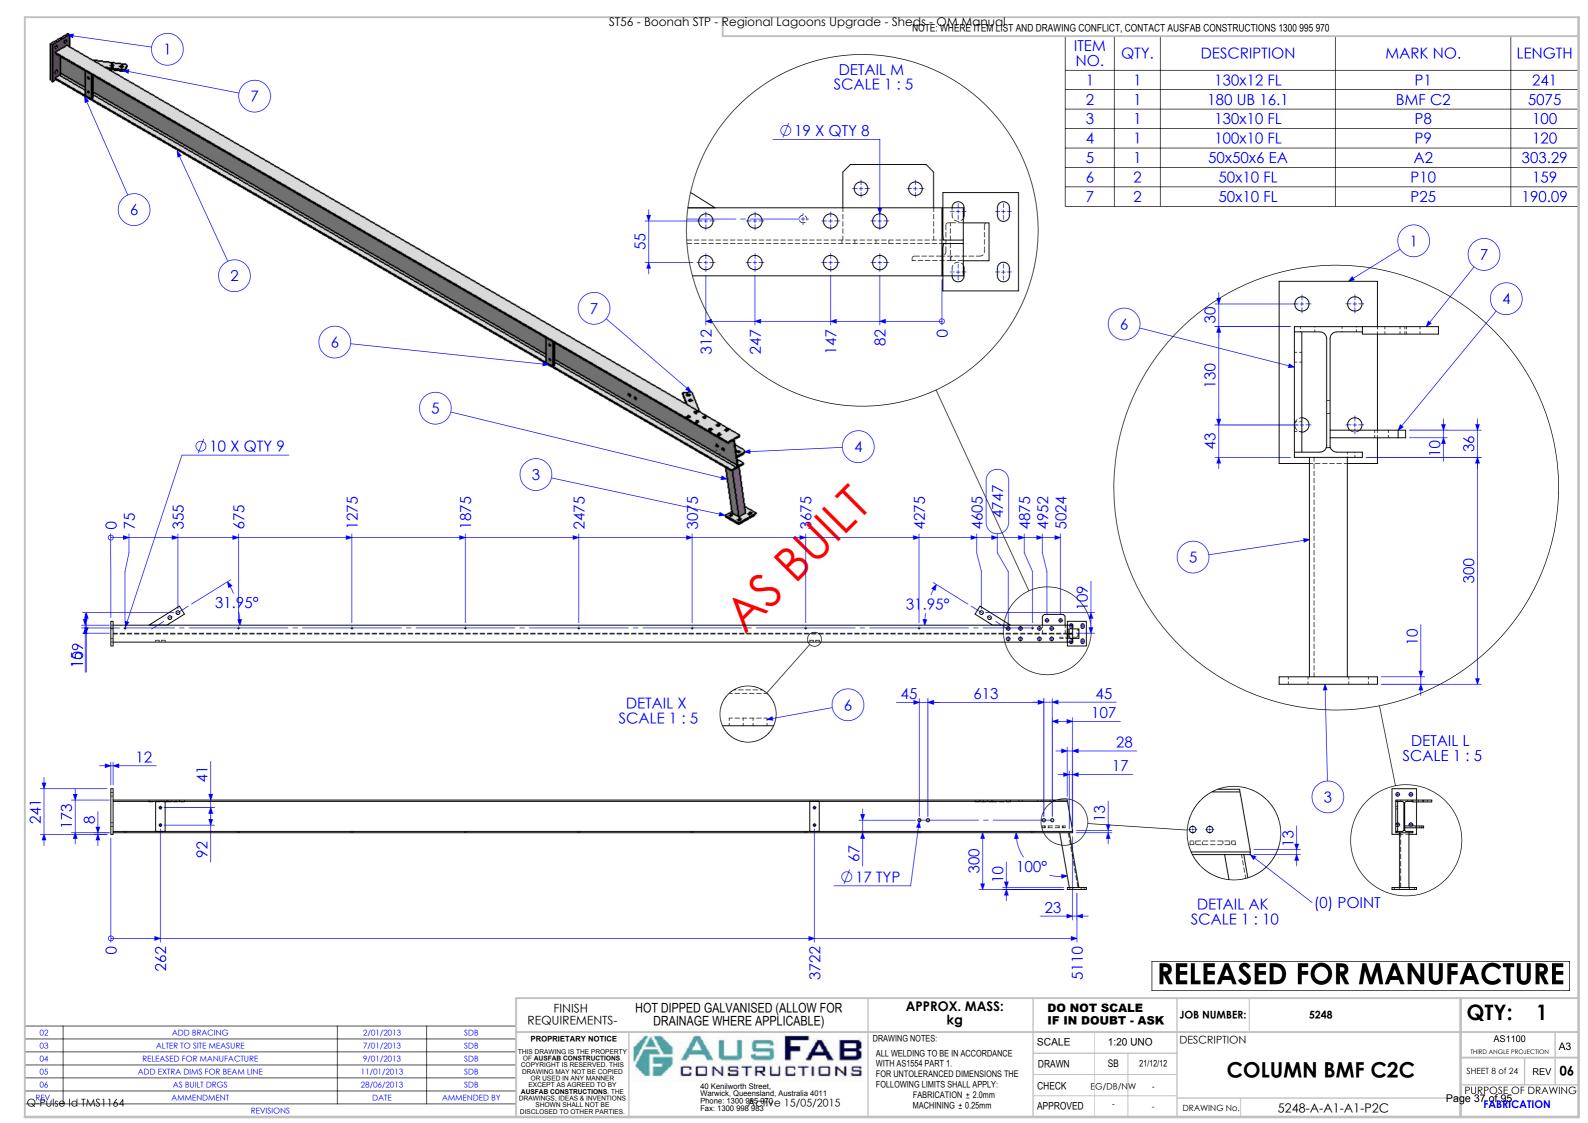


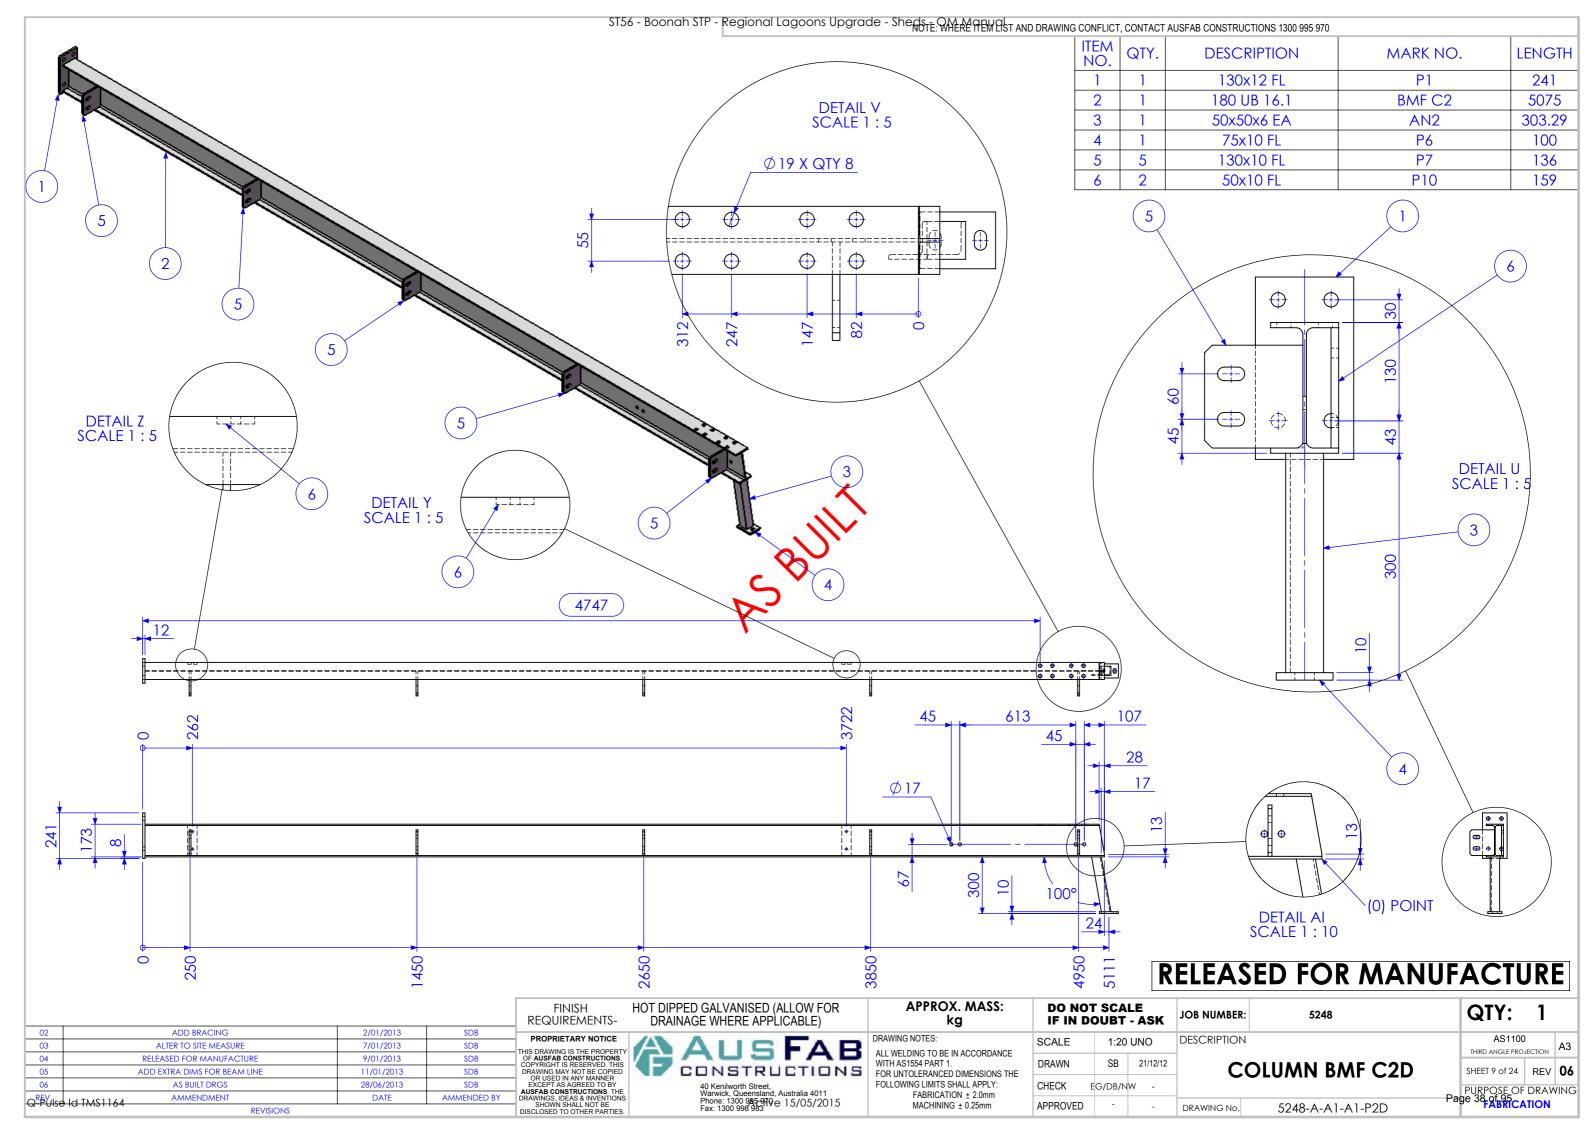


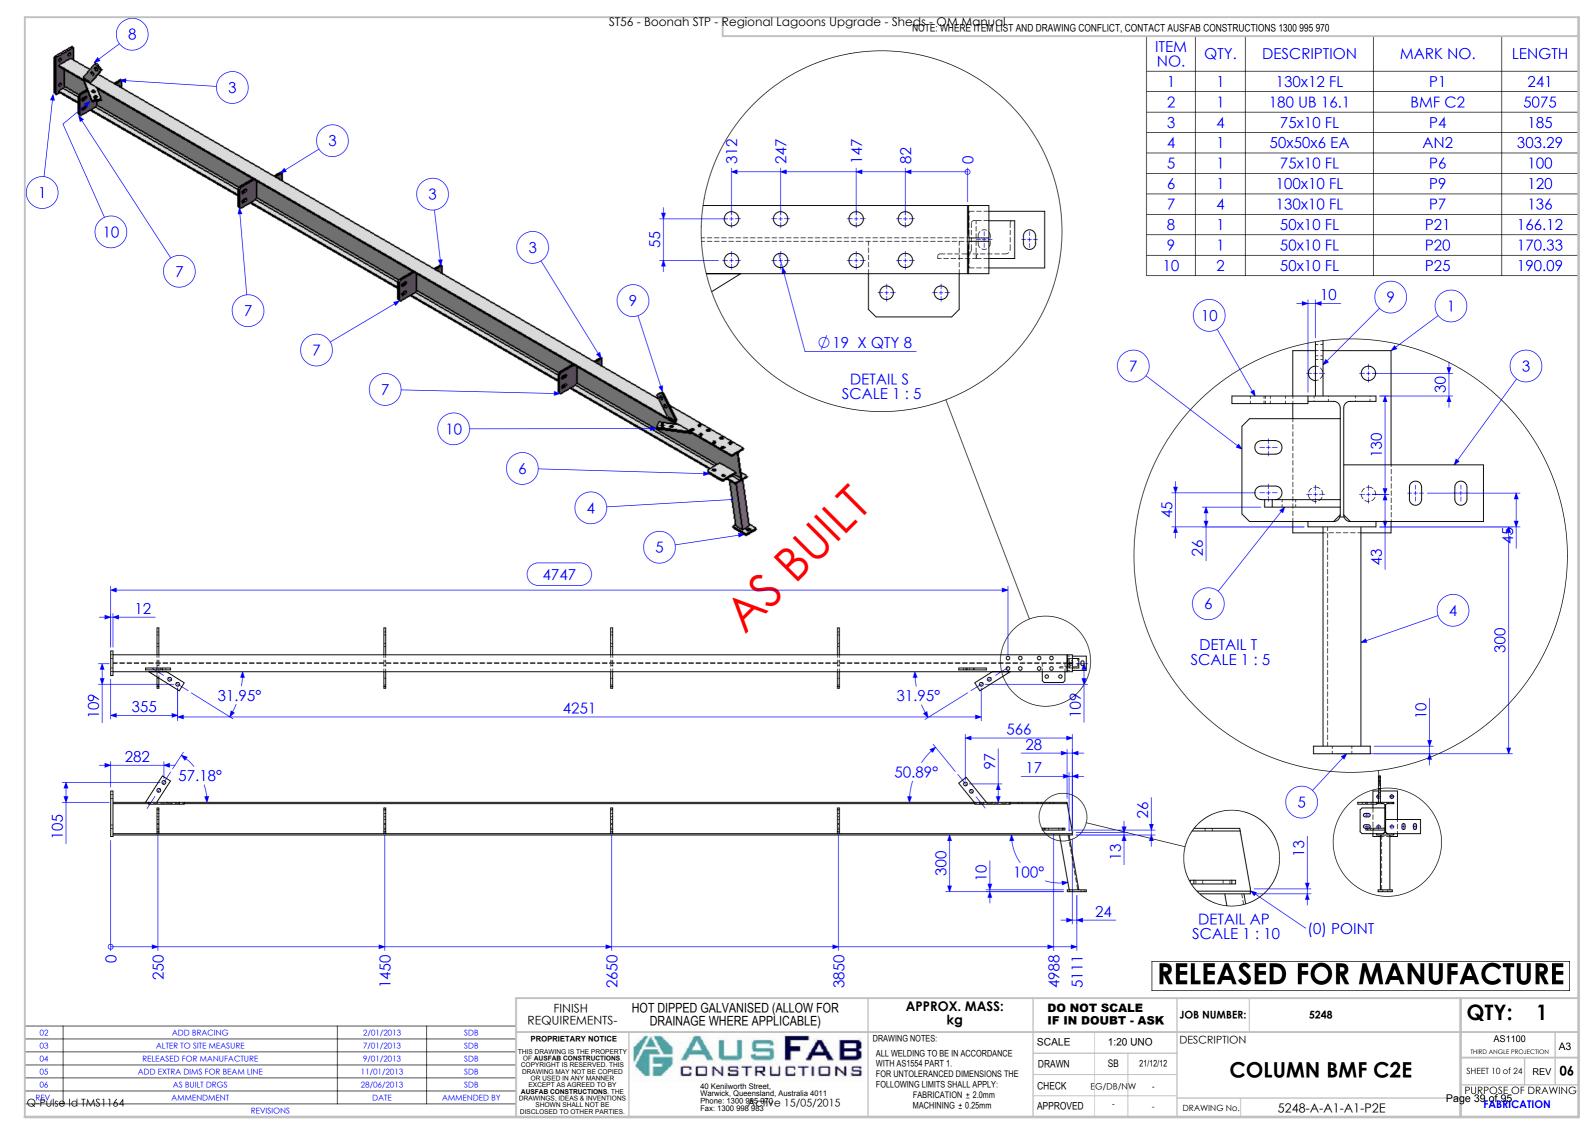


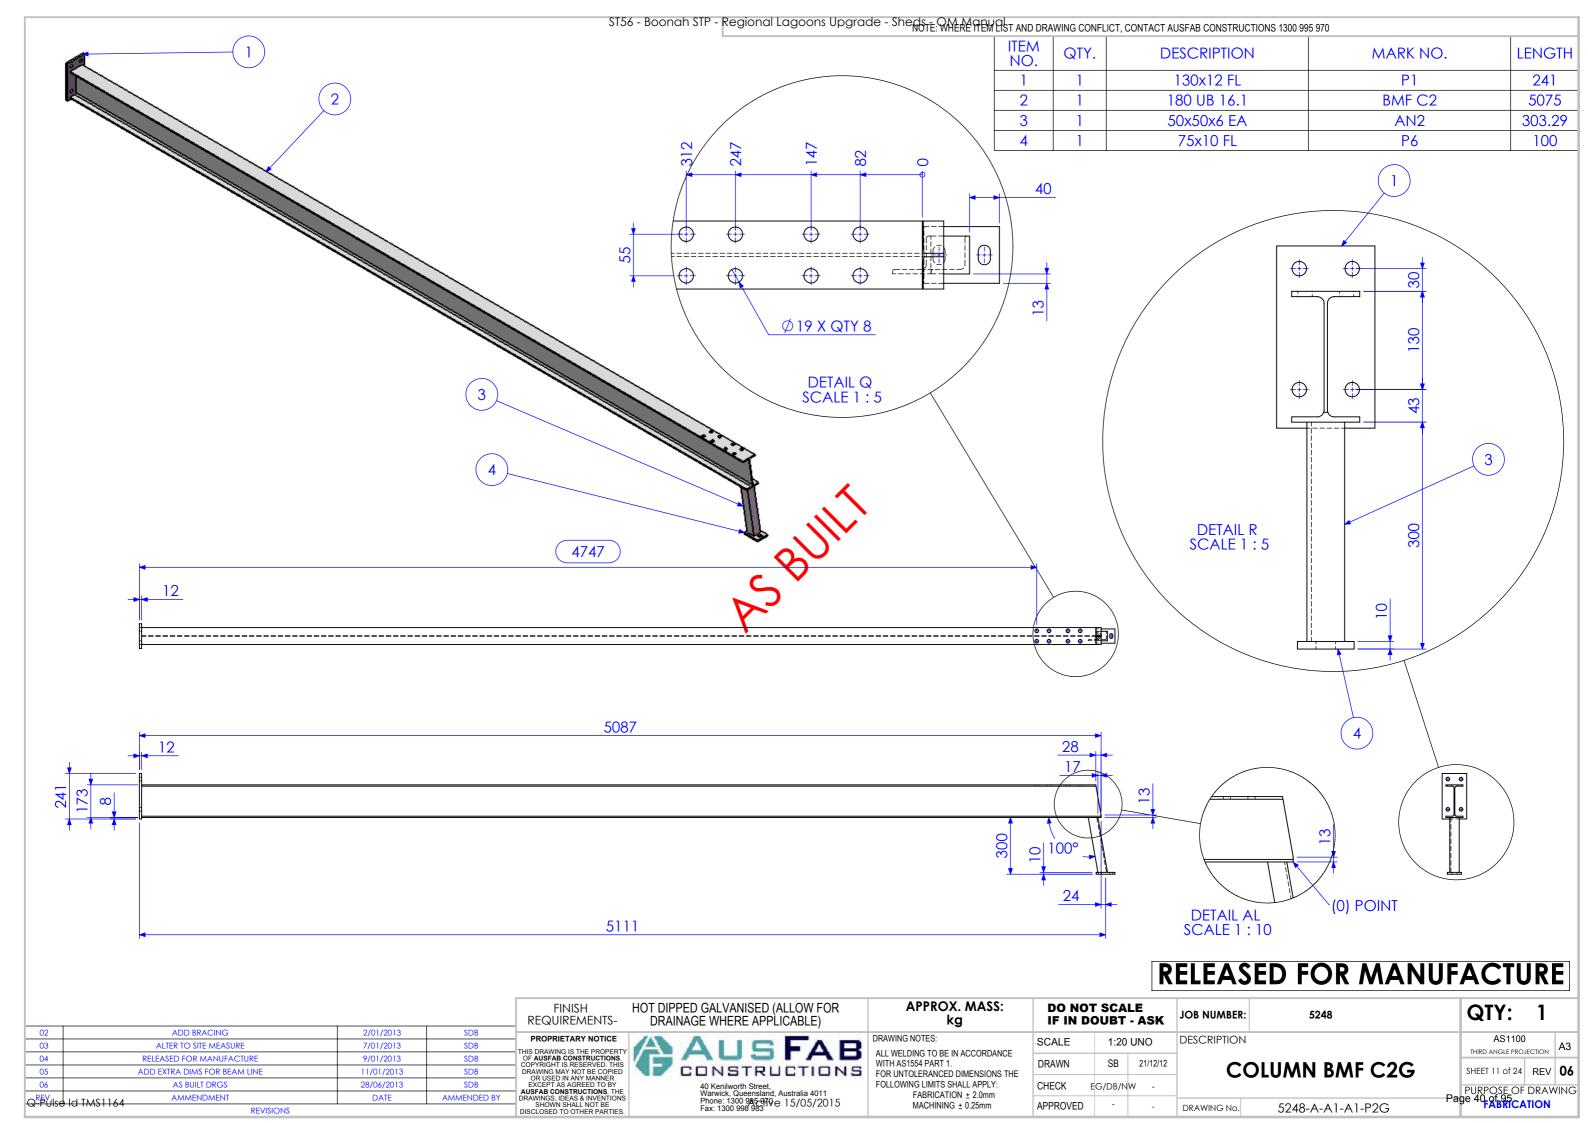


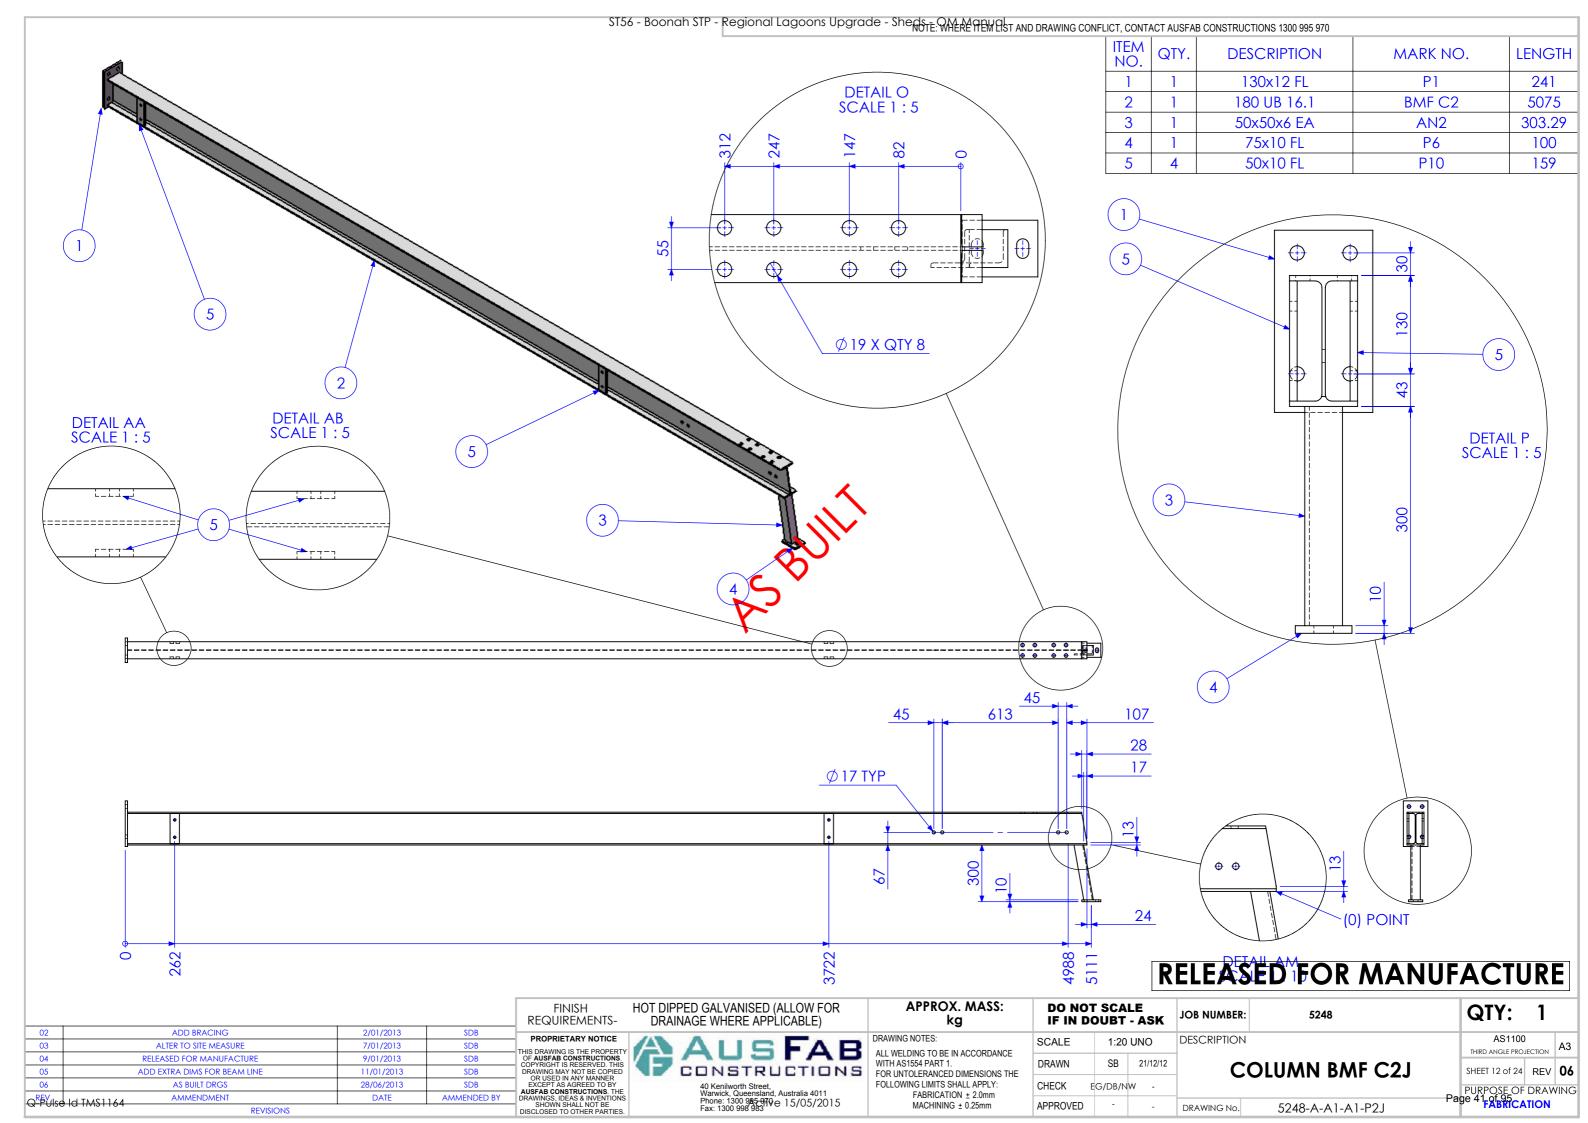


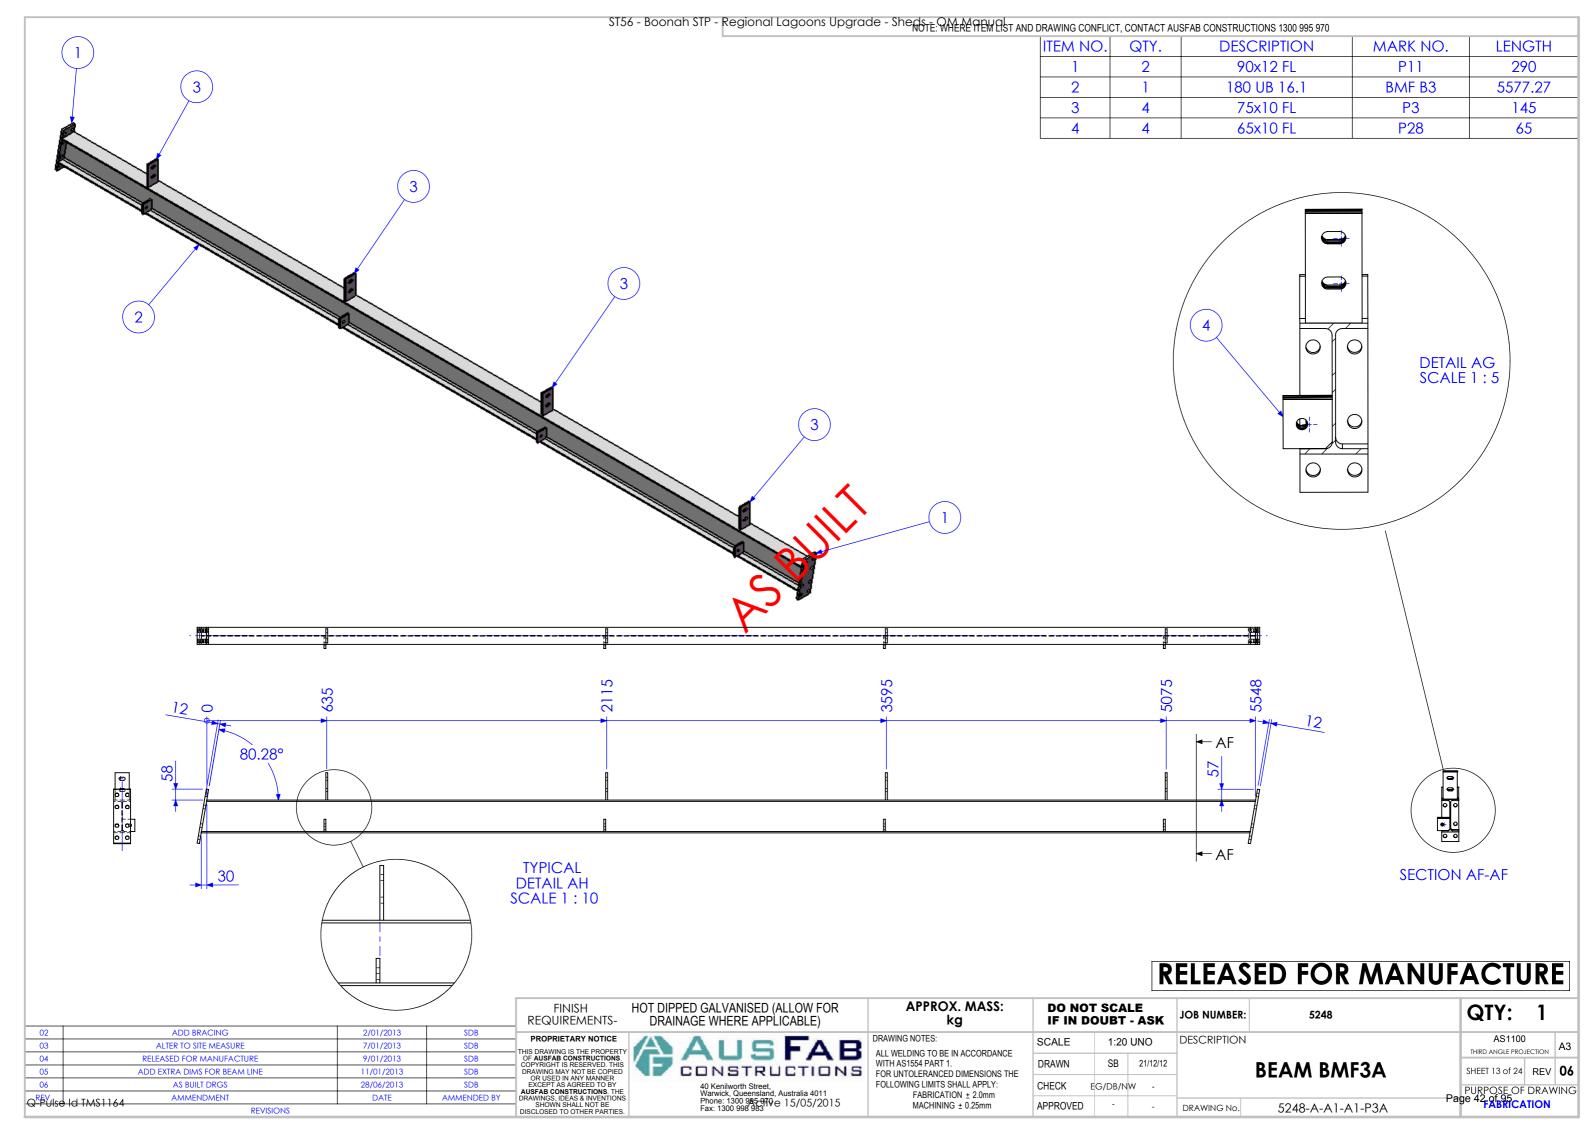


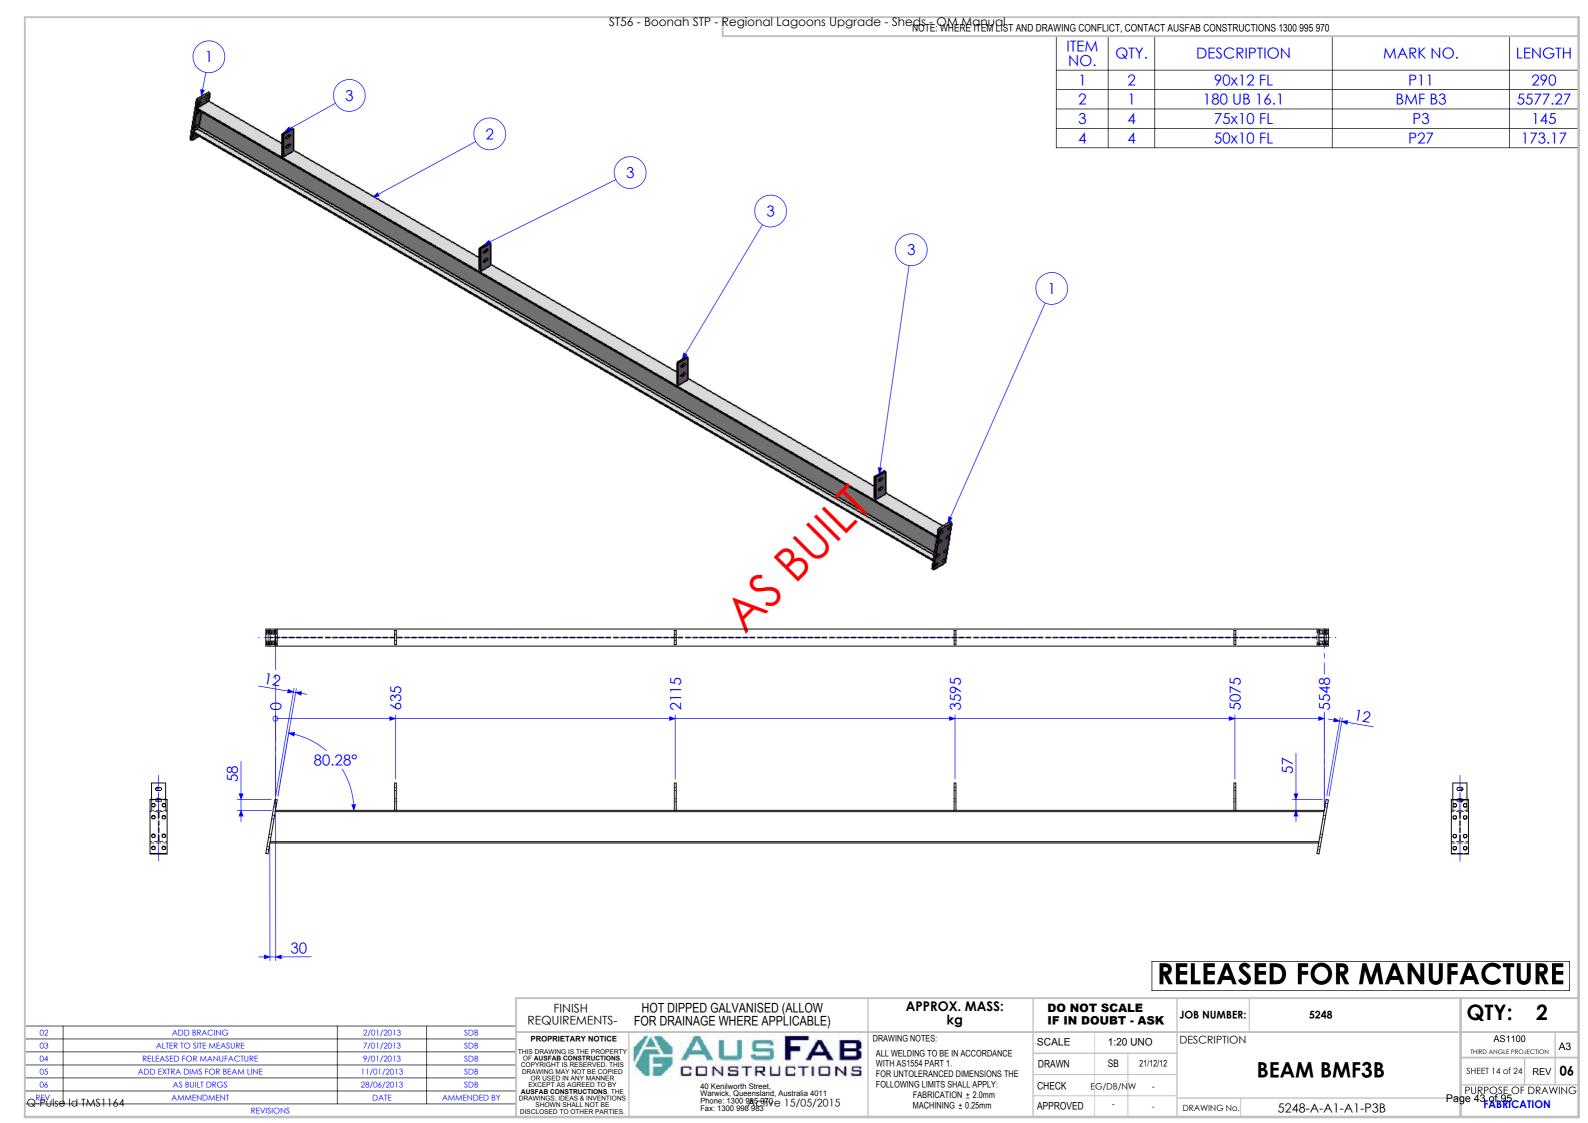


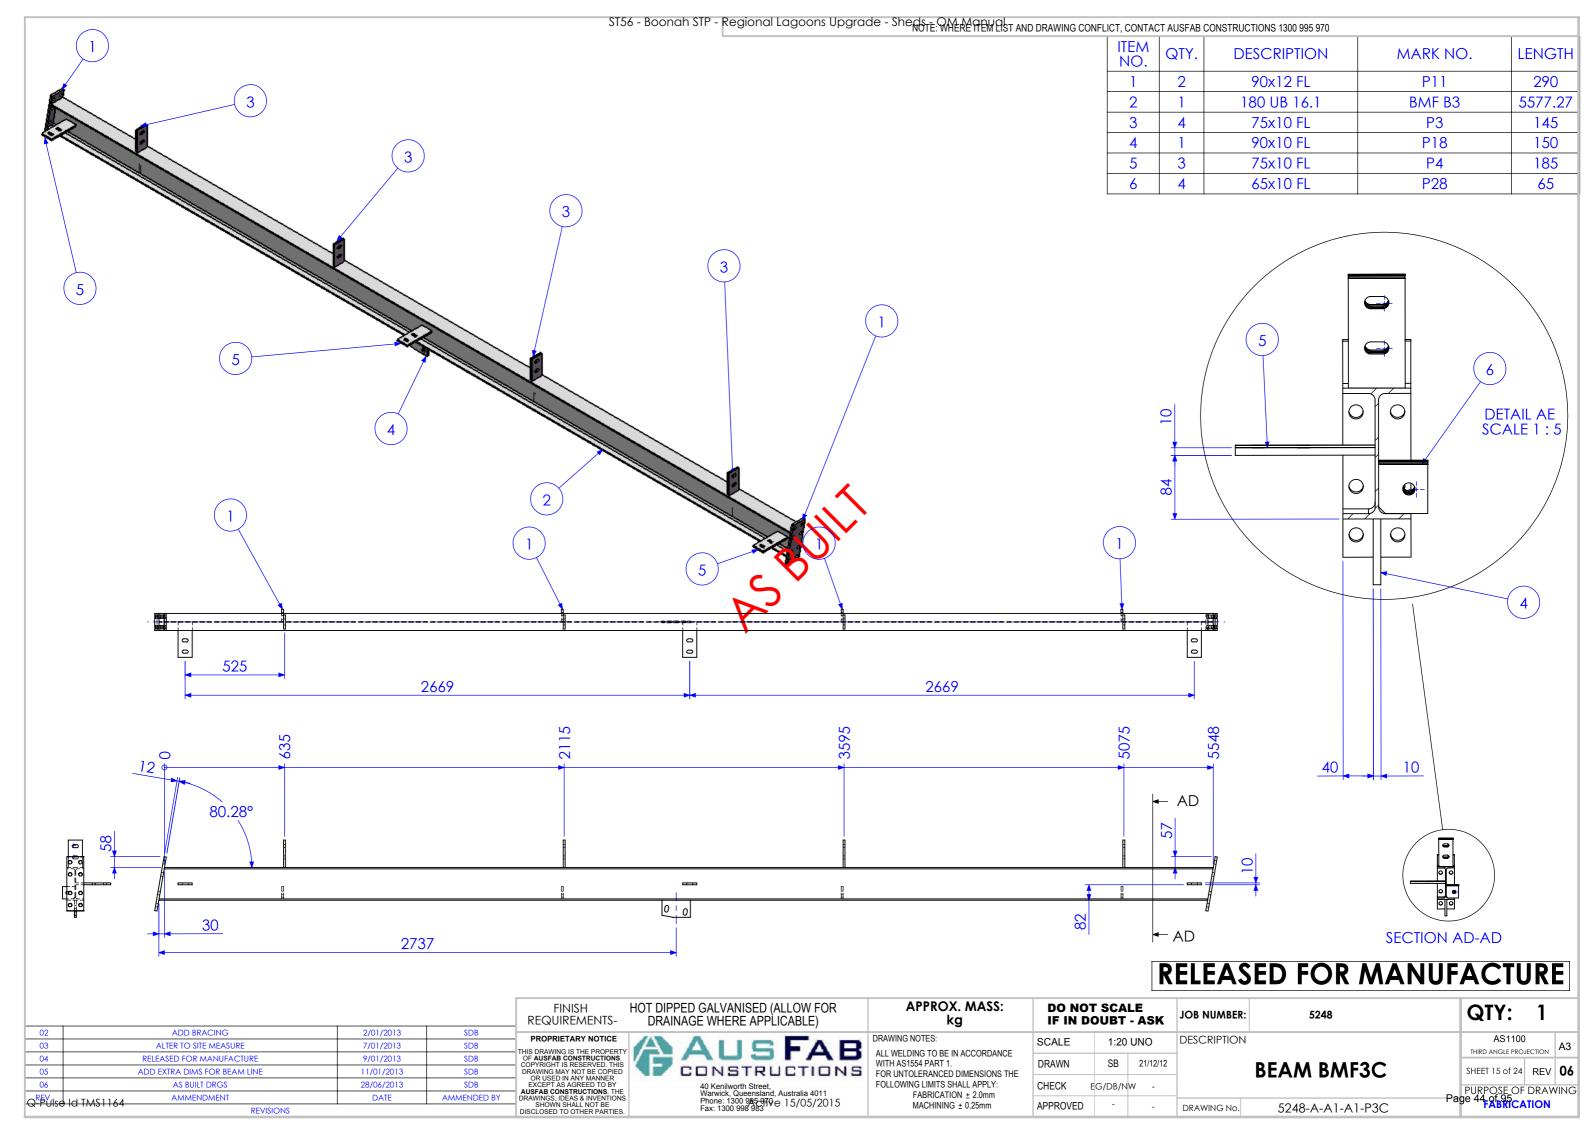

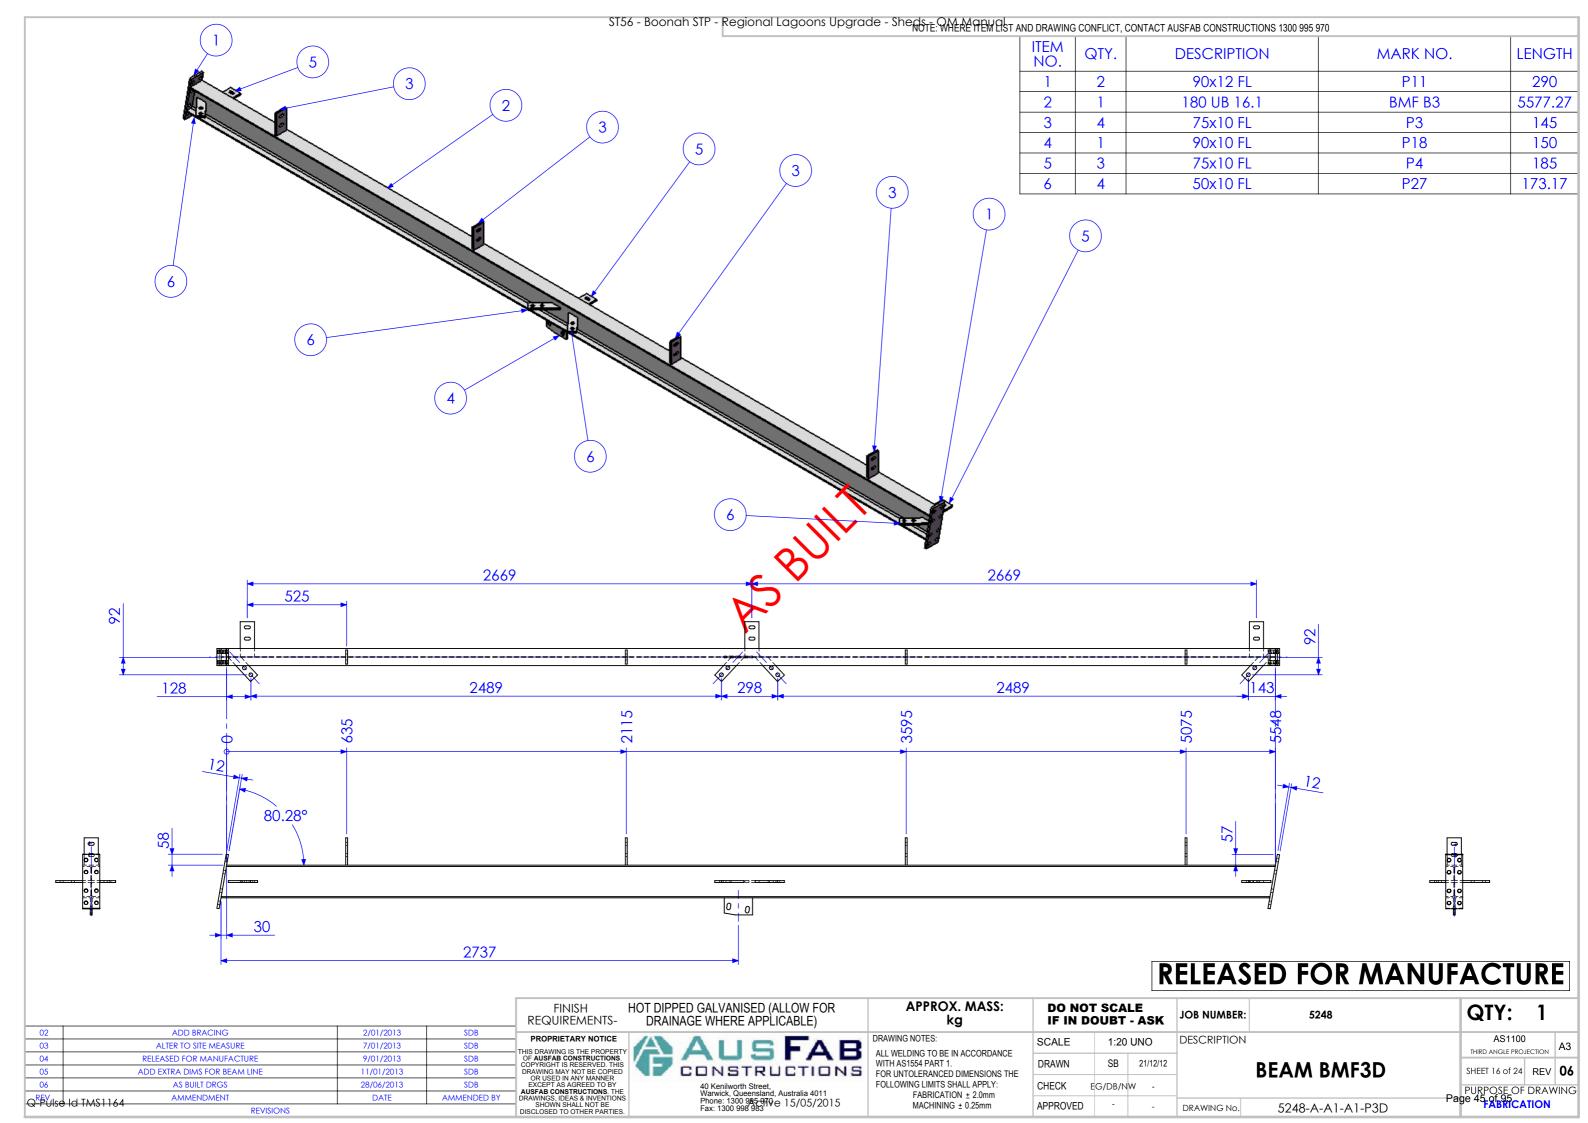


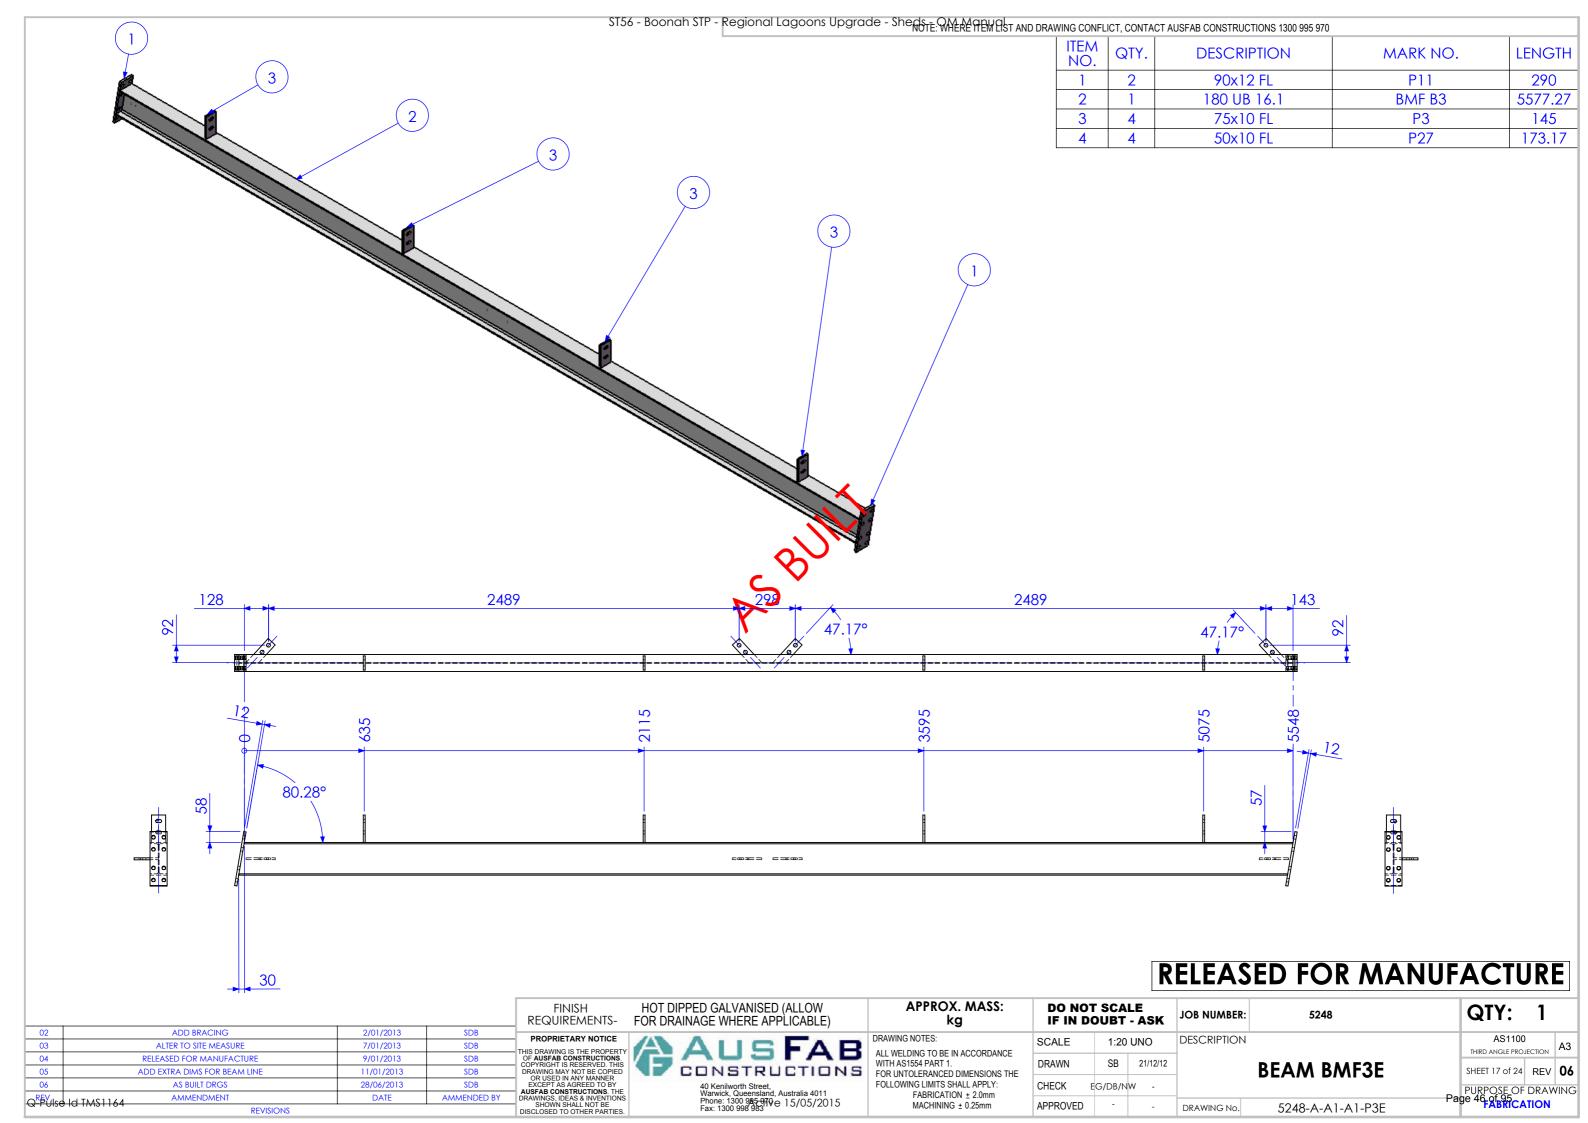


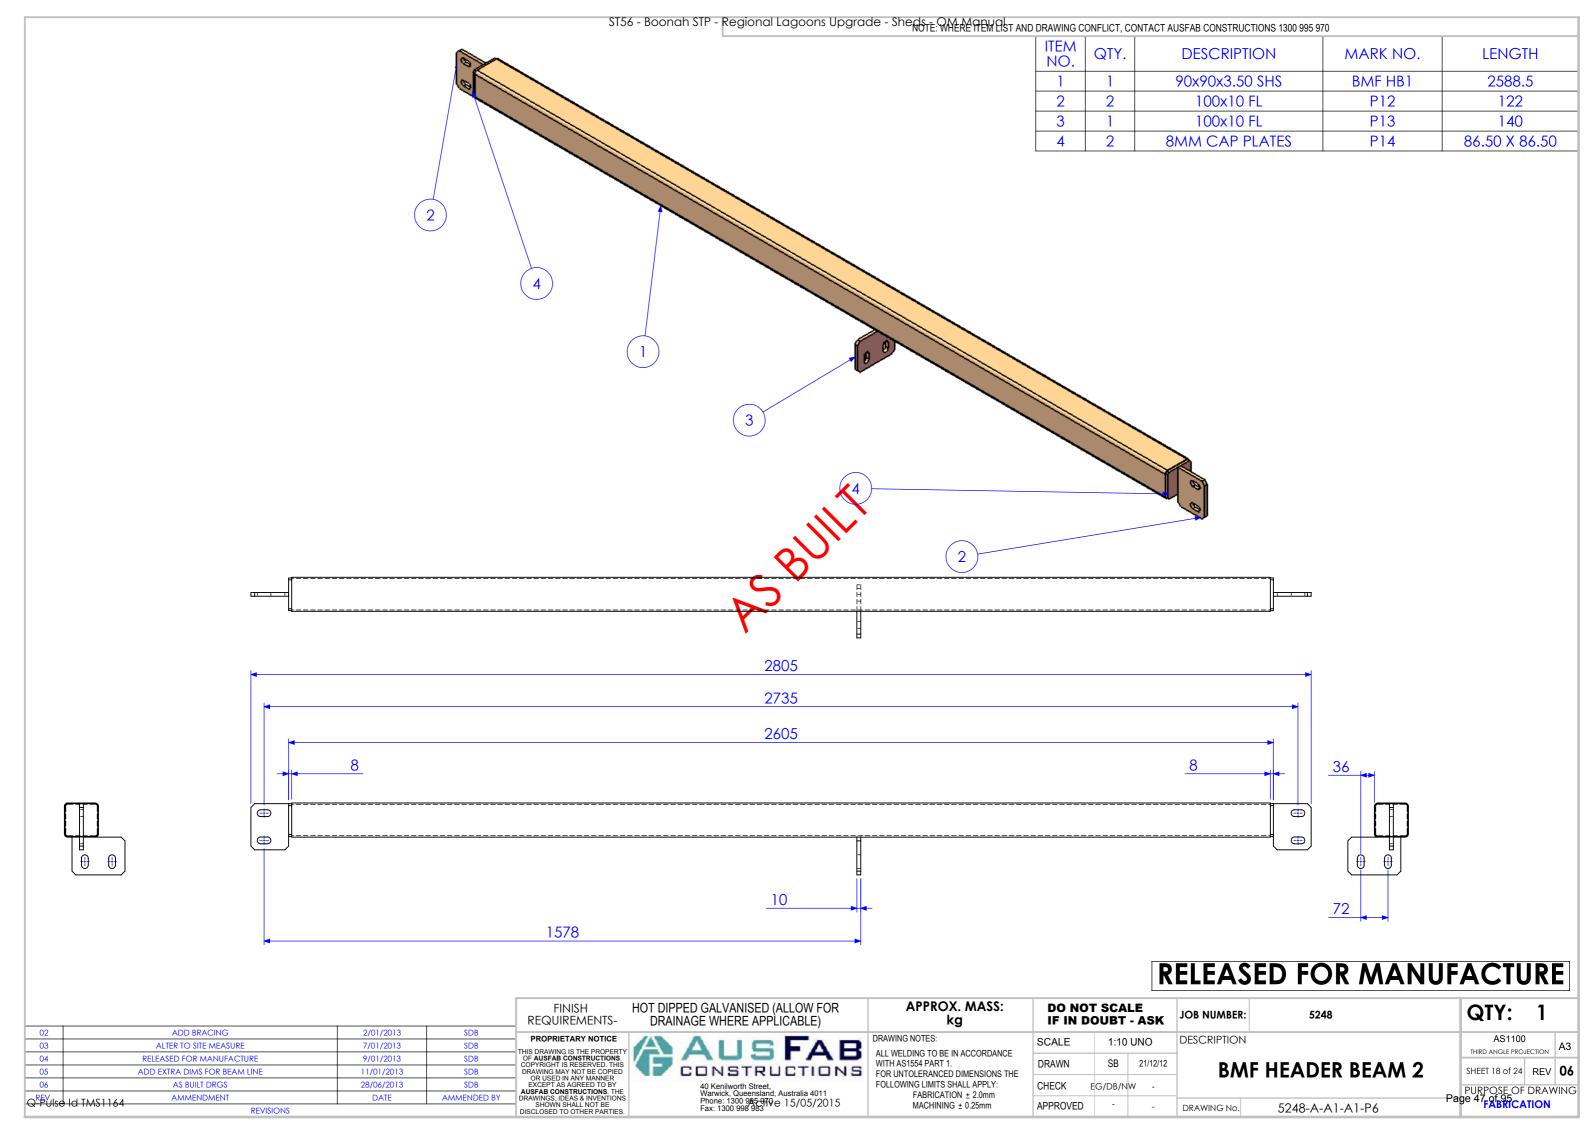


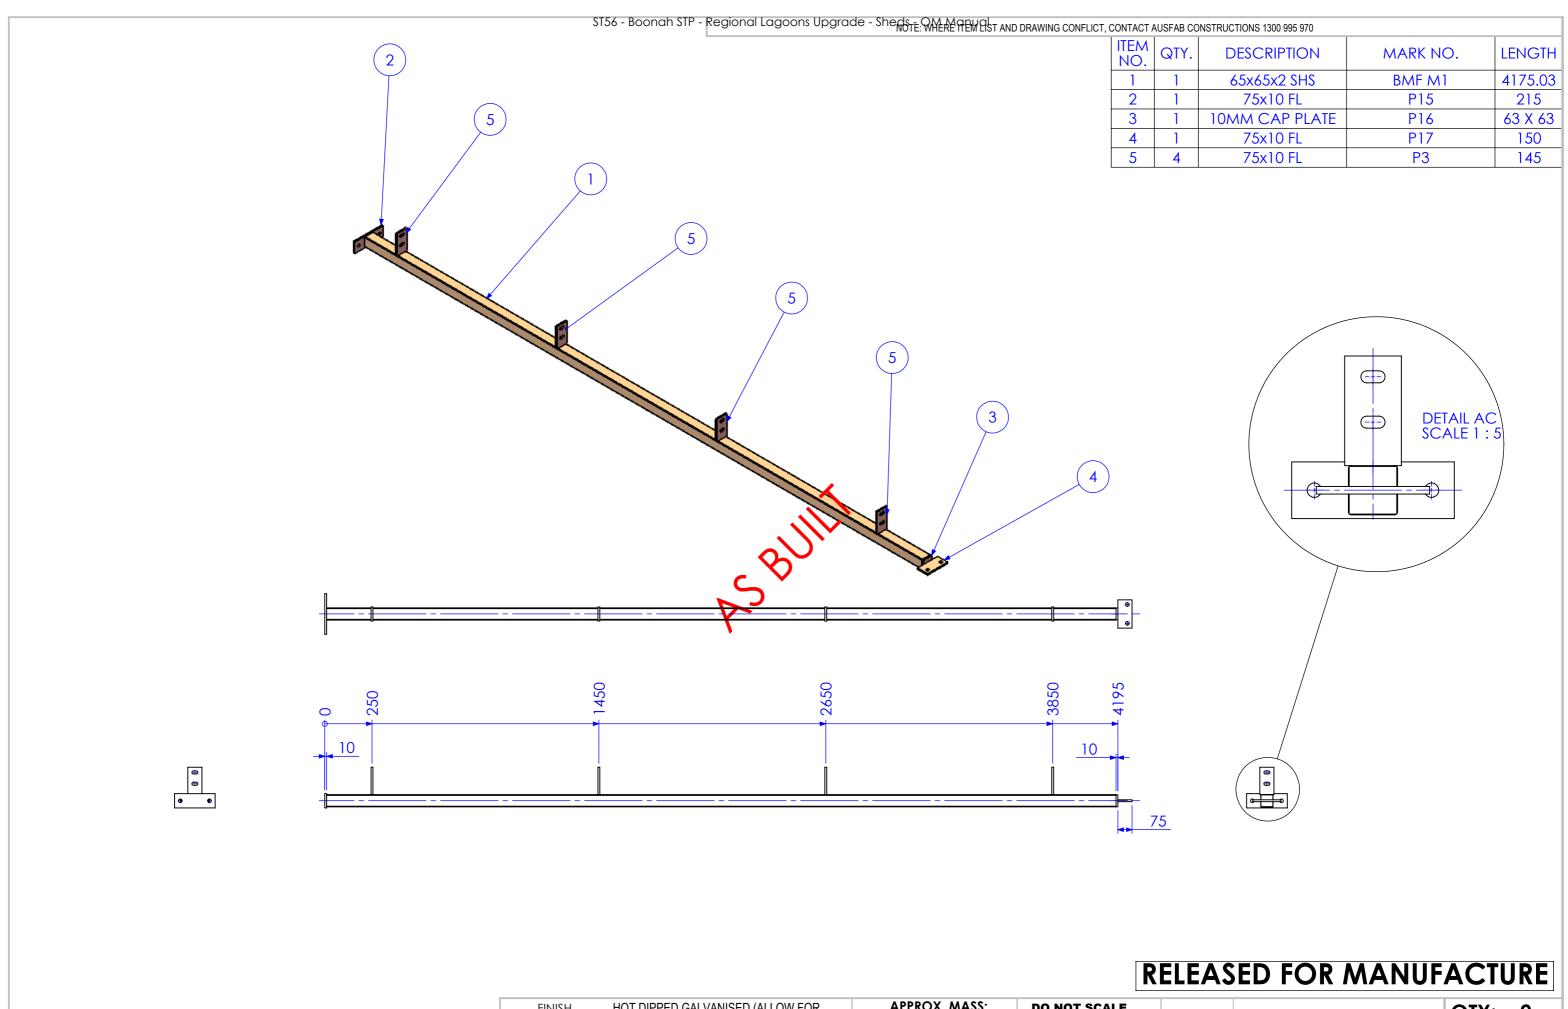



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	AS BUILT DRGS	28/06/2013	SDB	EXCEPT AS AGREED TO BY AUSFAB CONSTRUCTIONS. THE	40 Kenilworth Street, Warwick, Queensland, Australia 4011	FOLLOWING LIMITS SHALL APPLY:	CHECK	EG/DB/NW -			PURPOSE OF DRAWIN	
O.R	Ulse Id TMS1164 AMMENDMENT	DATE	AMMENDED BY	DRAWINGS, IDEAS & INVENTIONS	Warwick, Queensland, Australia 4011 S Phone: 1300 9 85-97 0 0 15 /05 /2015	FABRICATION ± 2.0mm					Page 48 of 95	9
4	REVISIONS	•	•	 SHOWN SHALL NOT BE DISCLOSED TO OTHER PARTIES 	Phone: 1300 985 970 e 15/05/2015 Fax: 1300 998 983	MACHINING ± 0.25mm	APPROVED		DRAWING No.	5248-A-A1-A1-P4	FABRICATION	

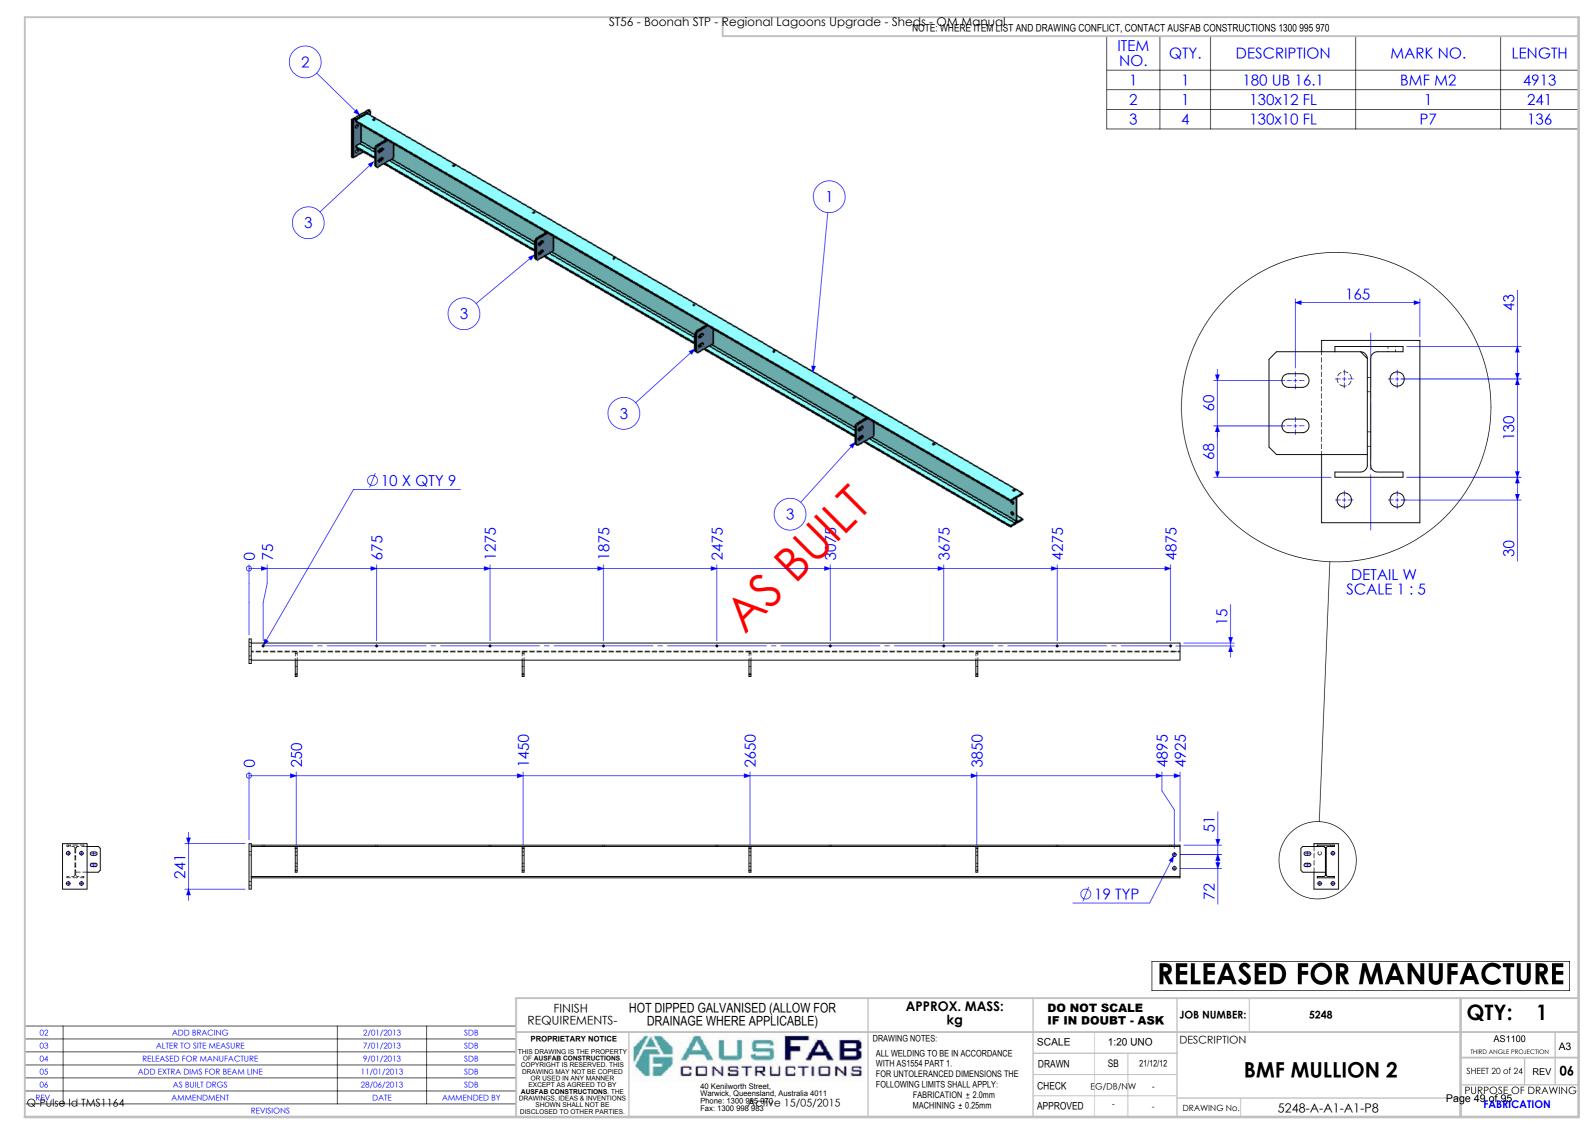


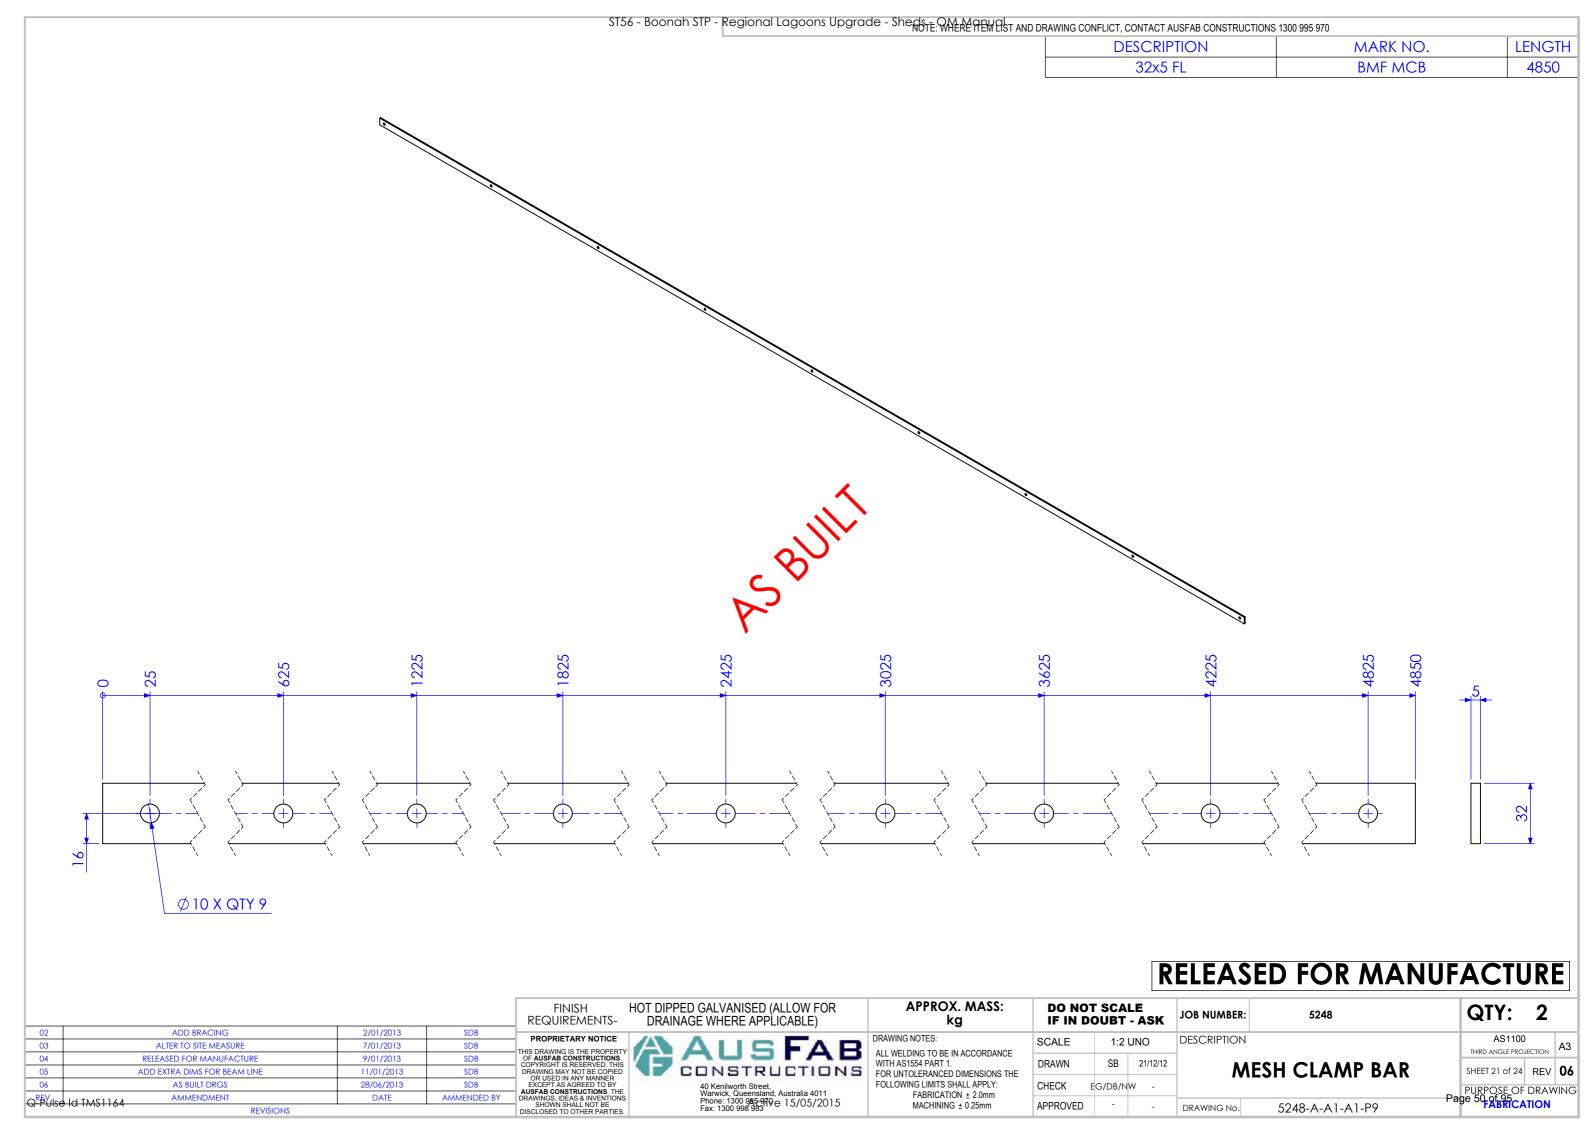


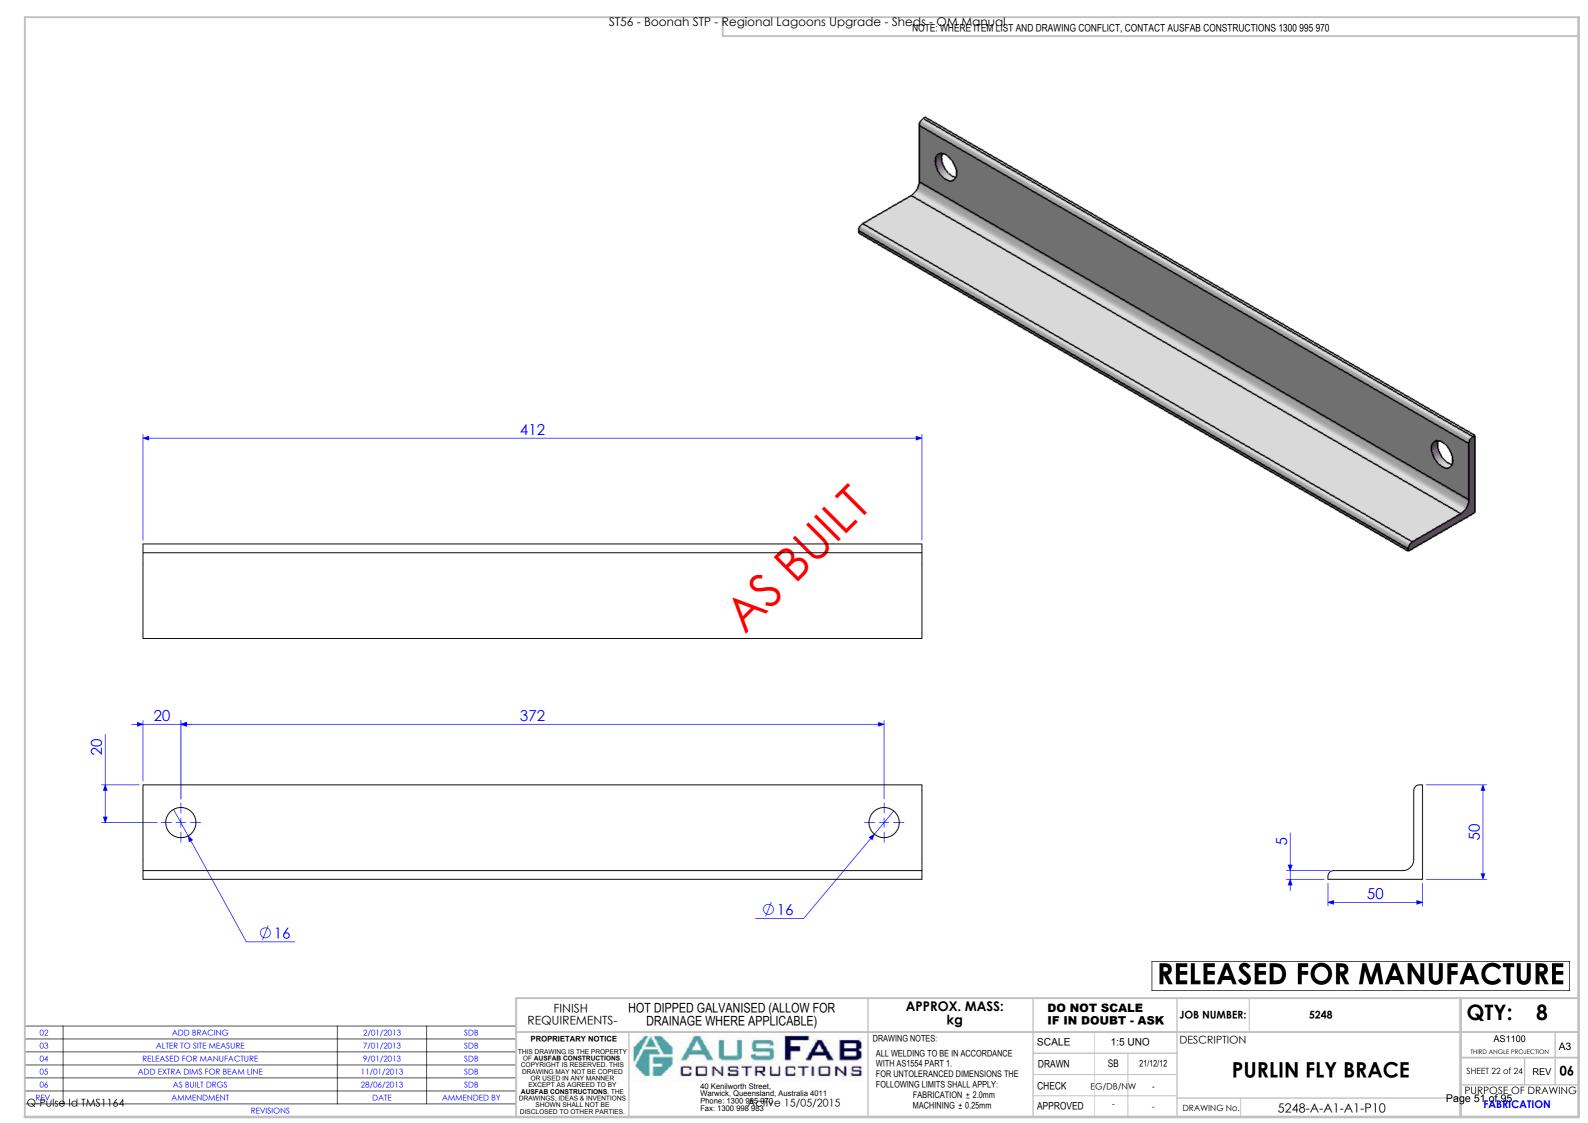


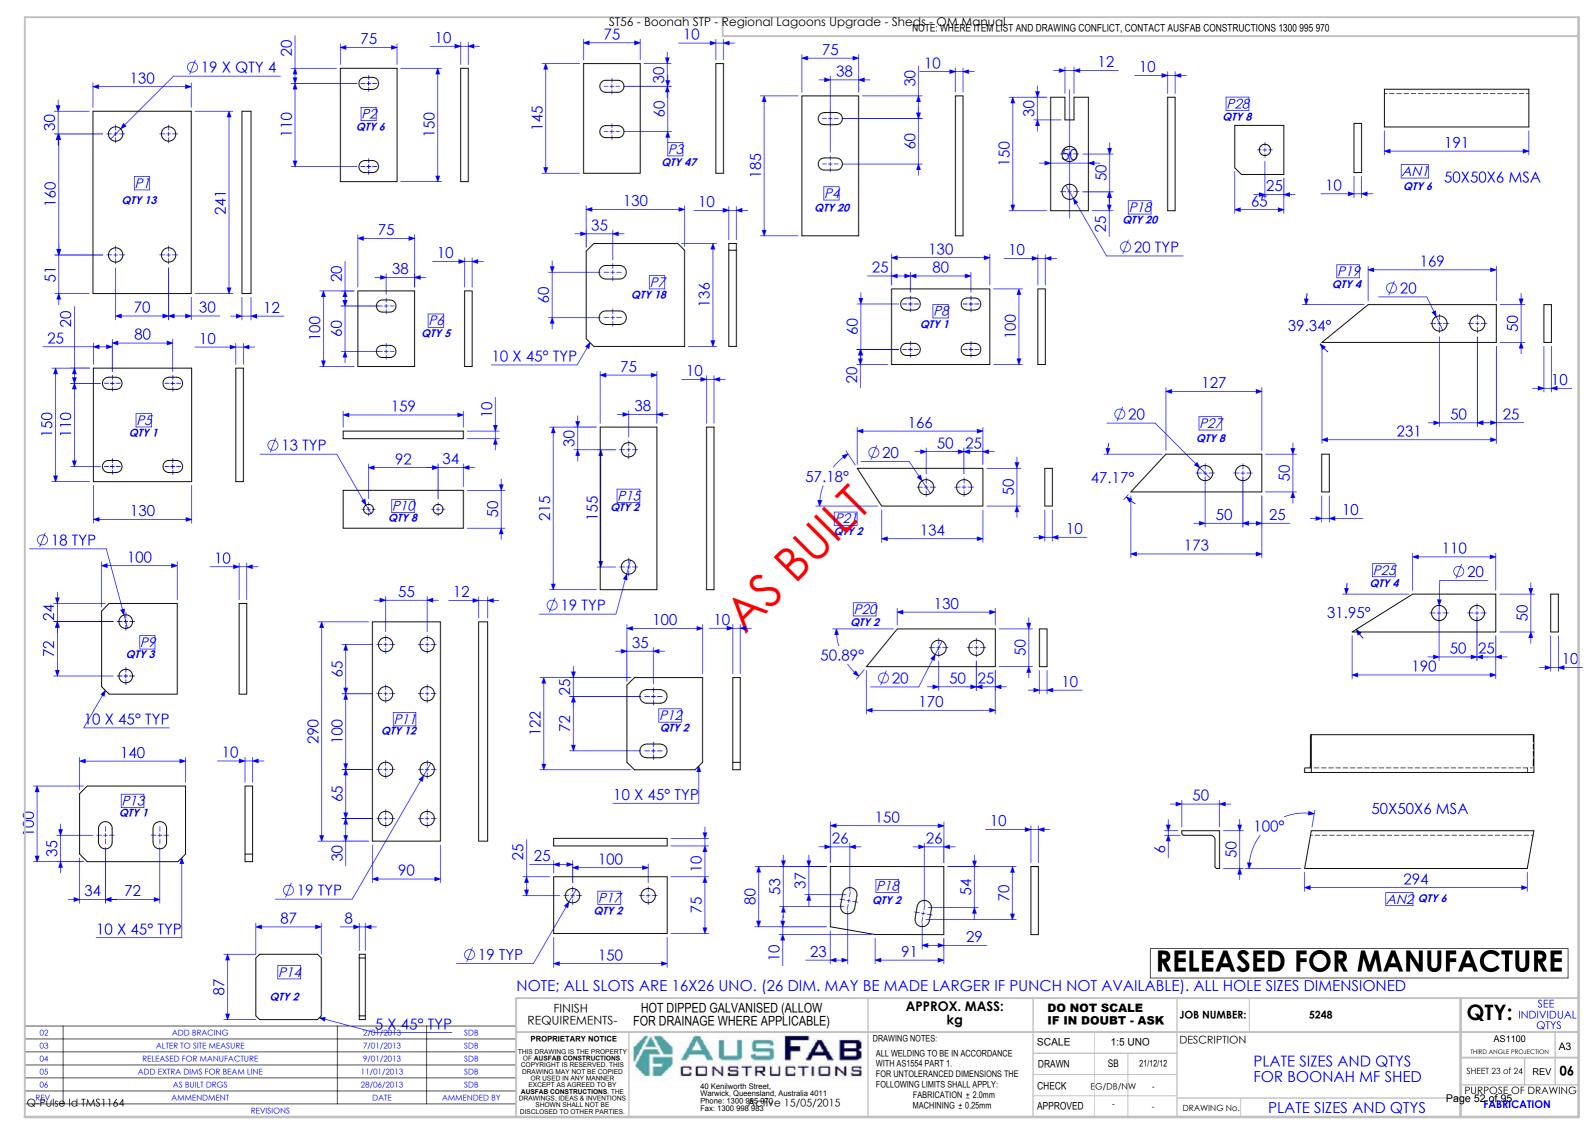

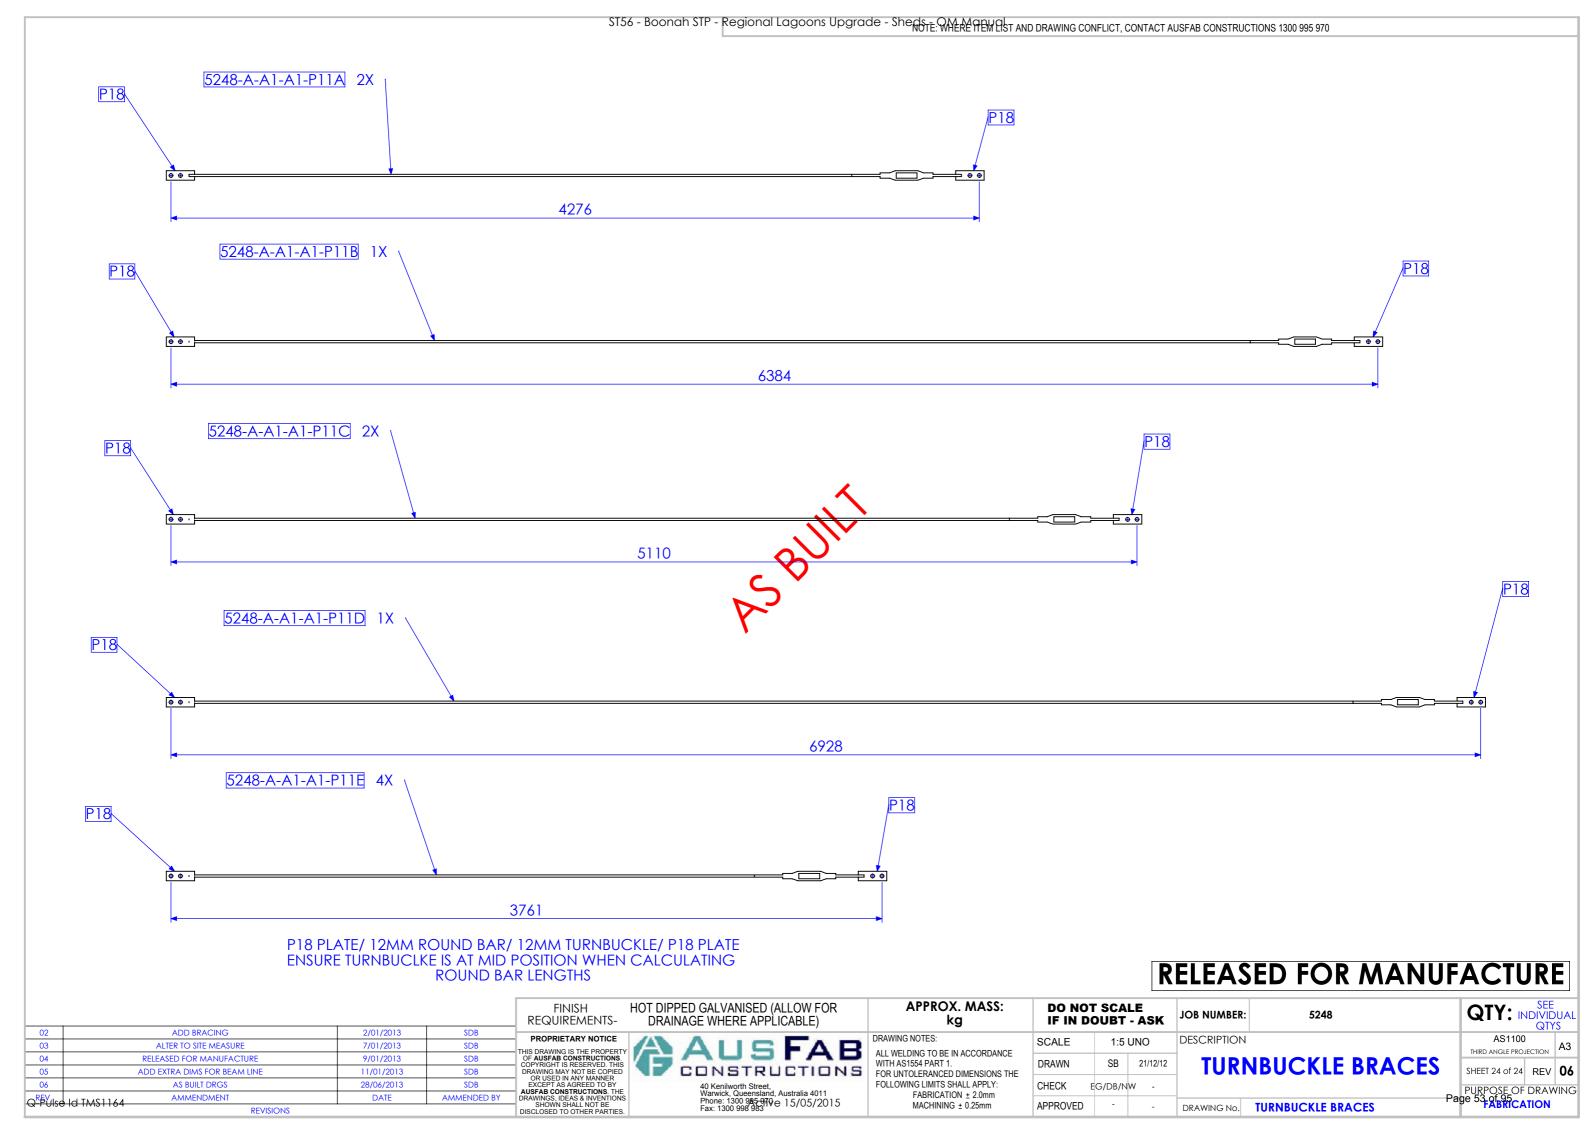

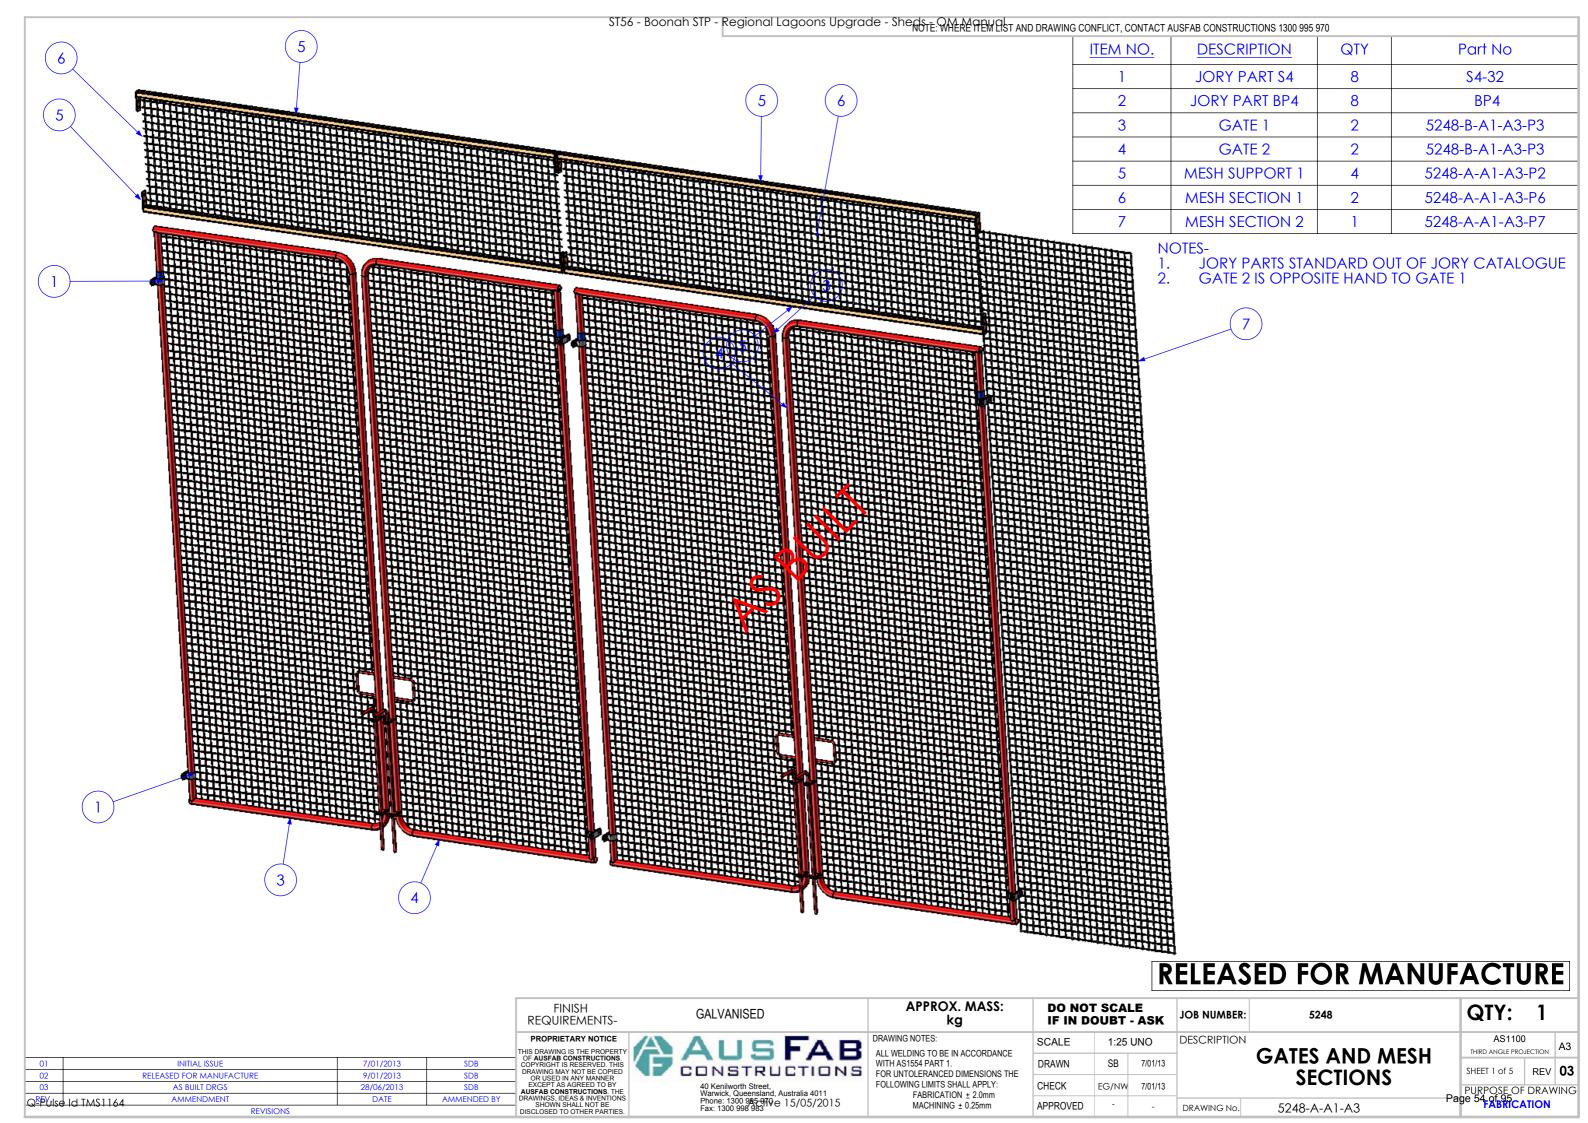


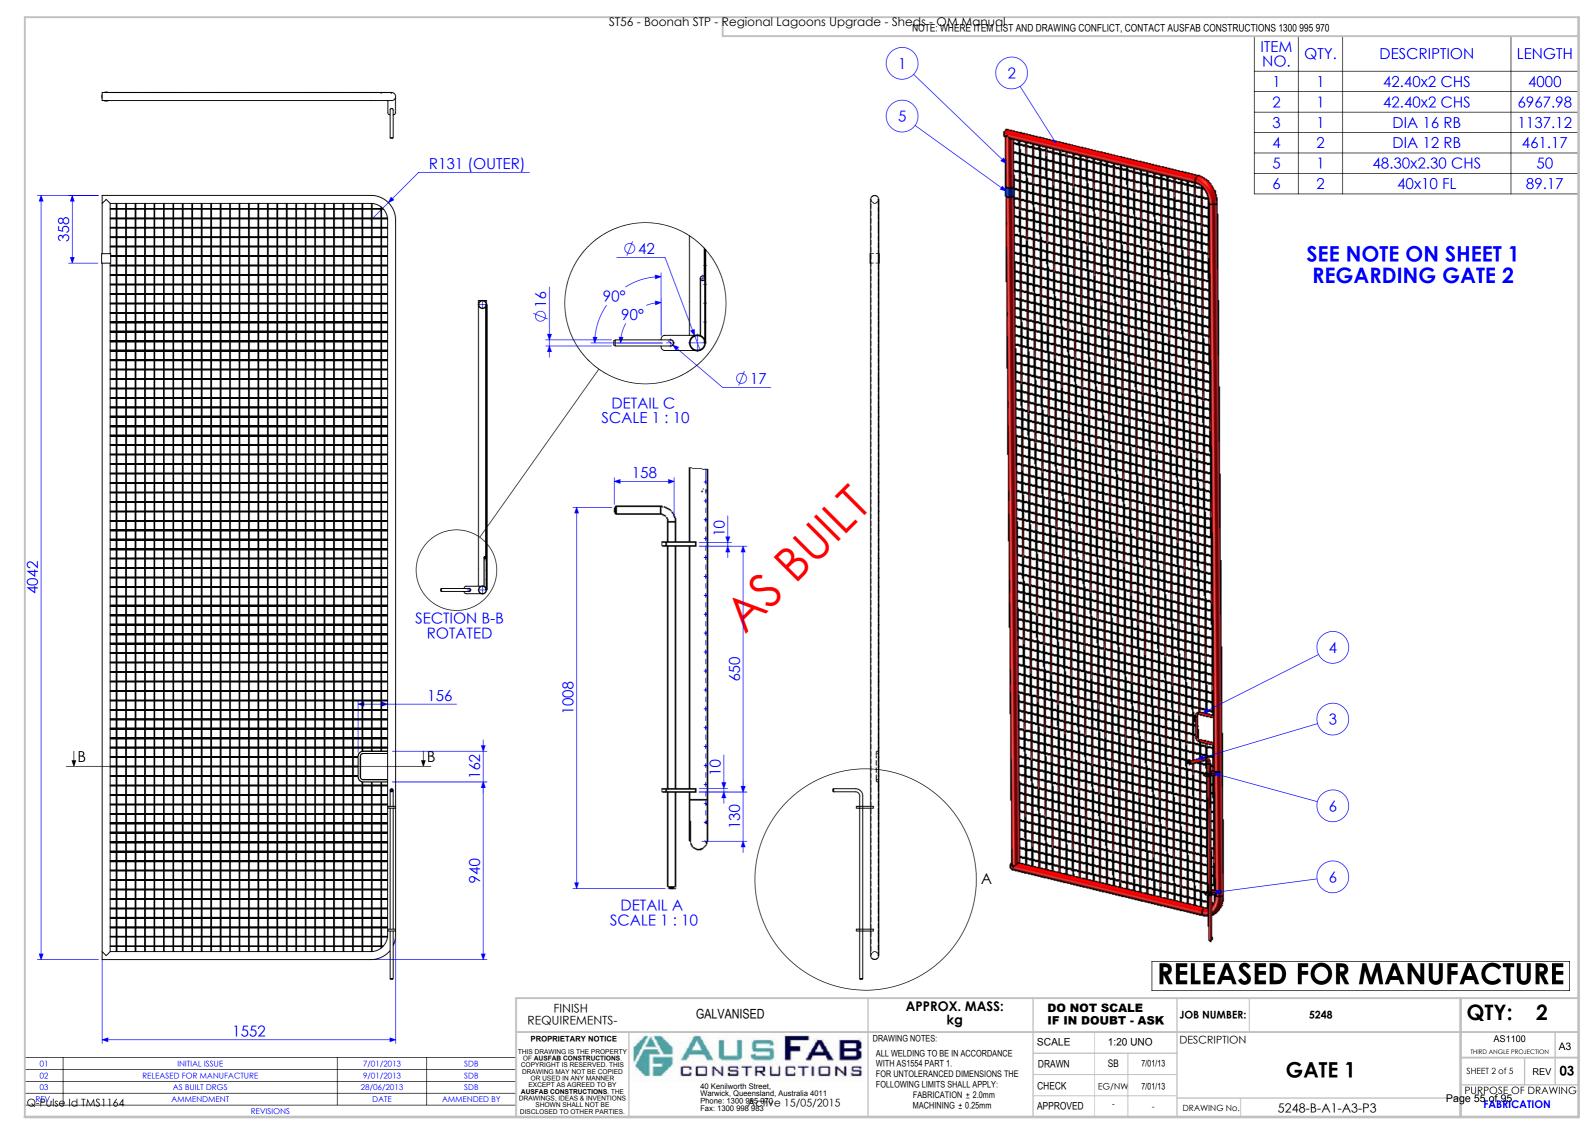

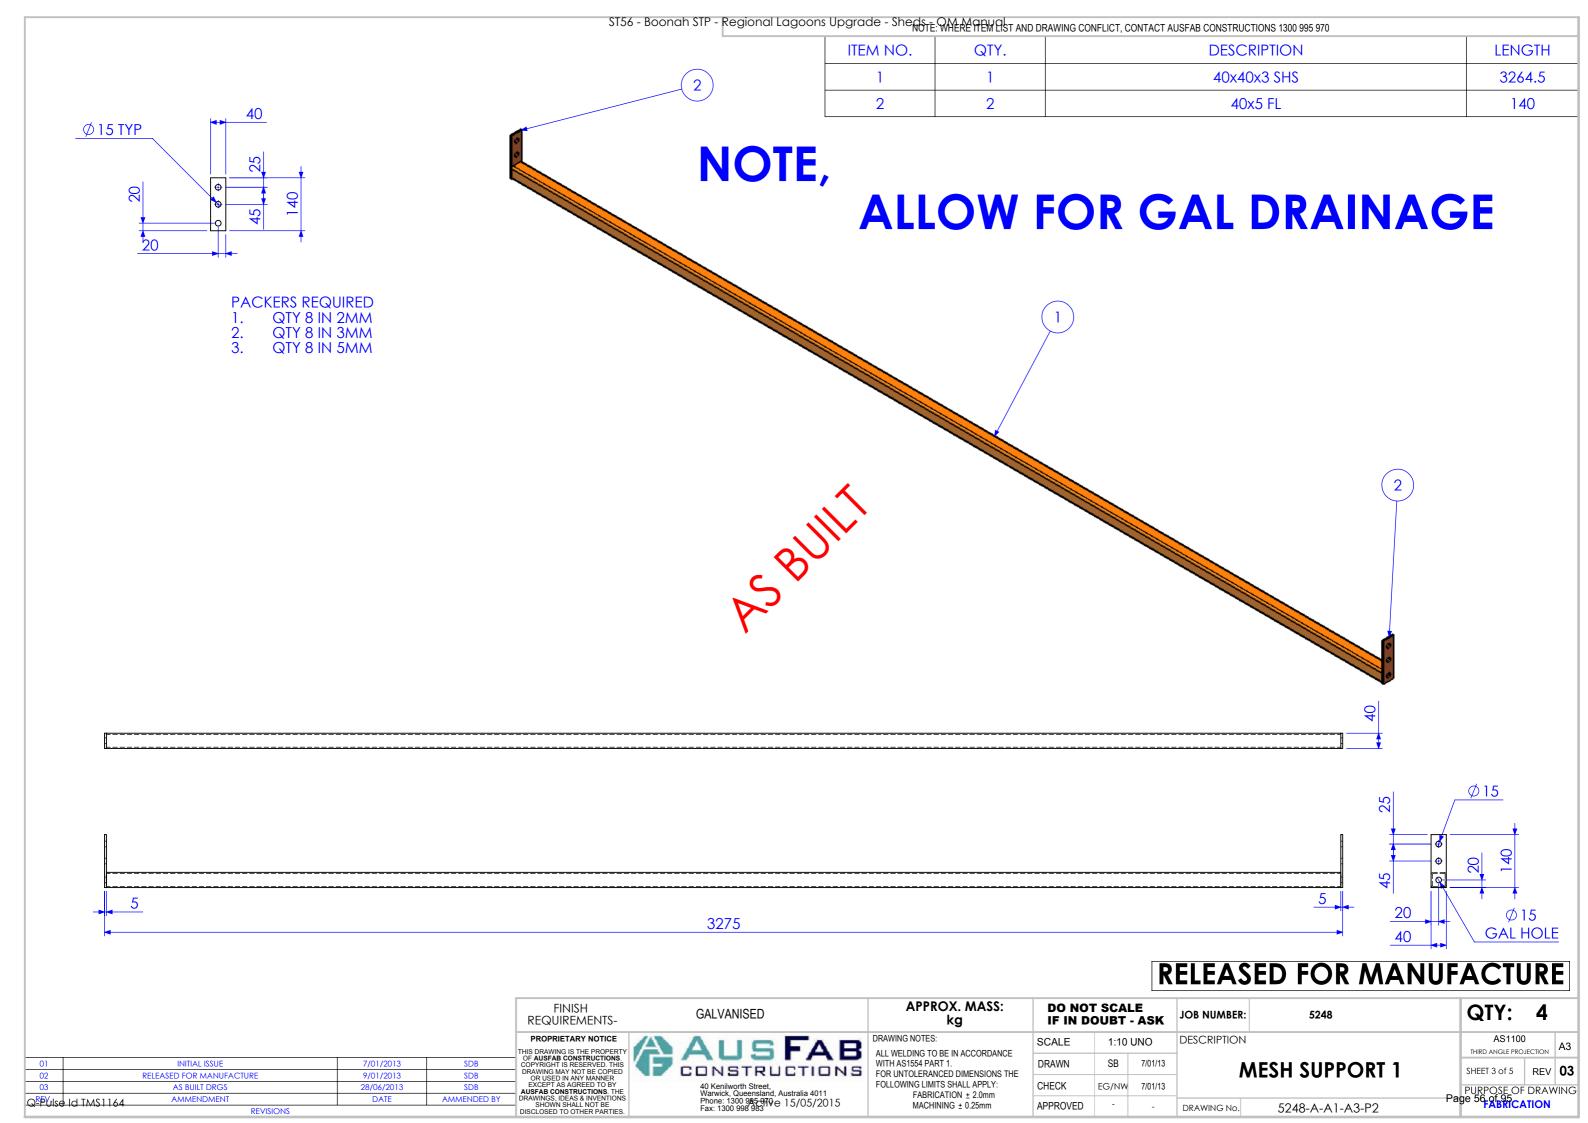

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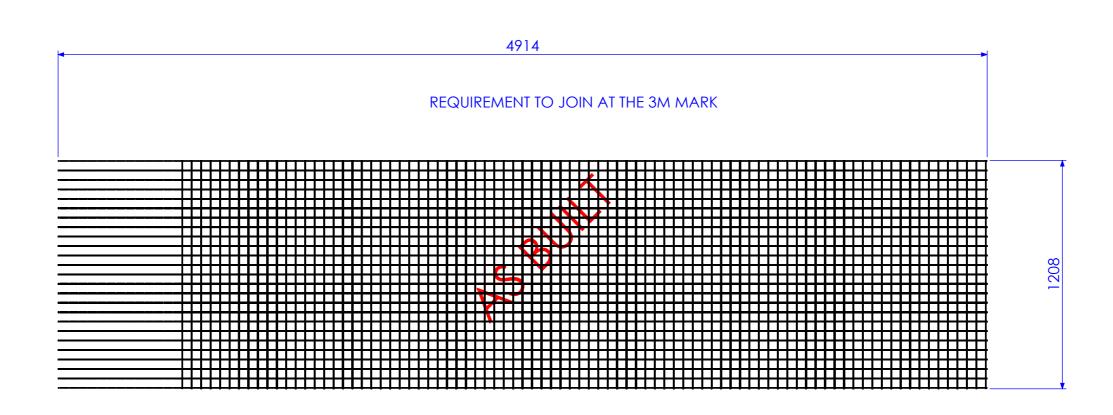
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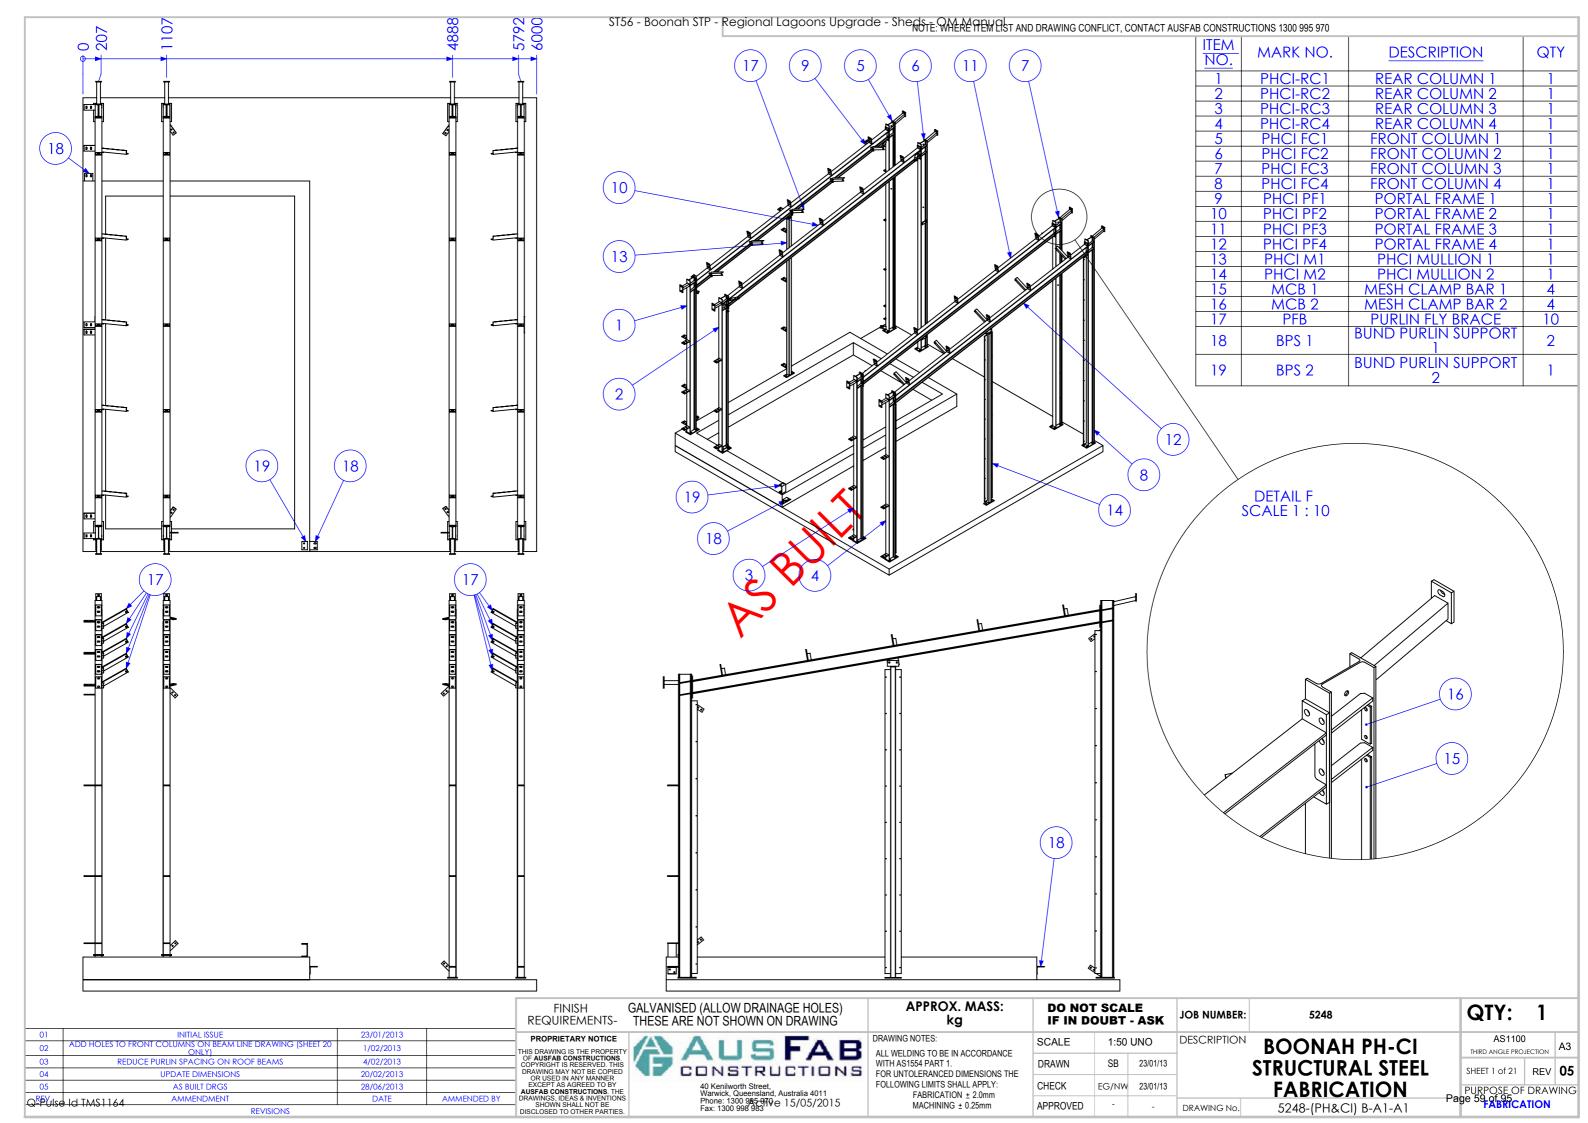
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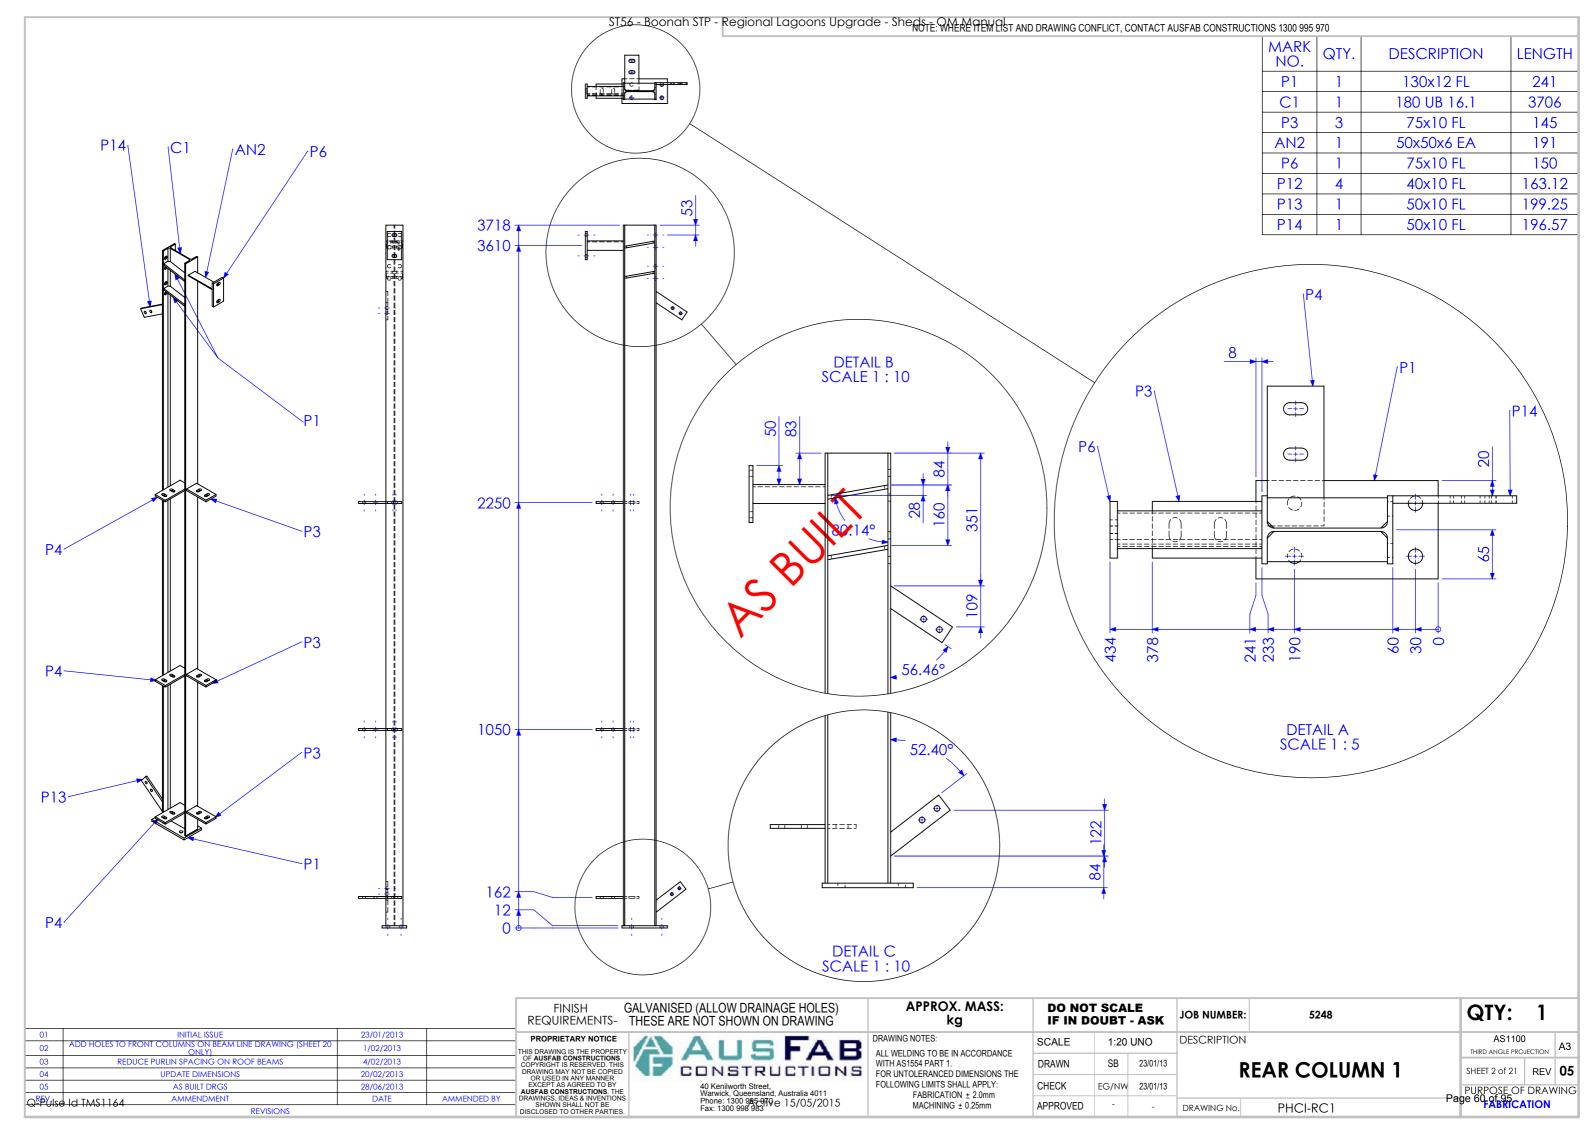



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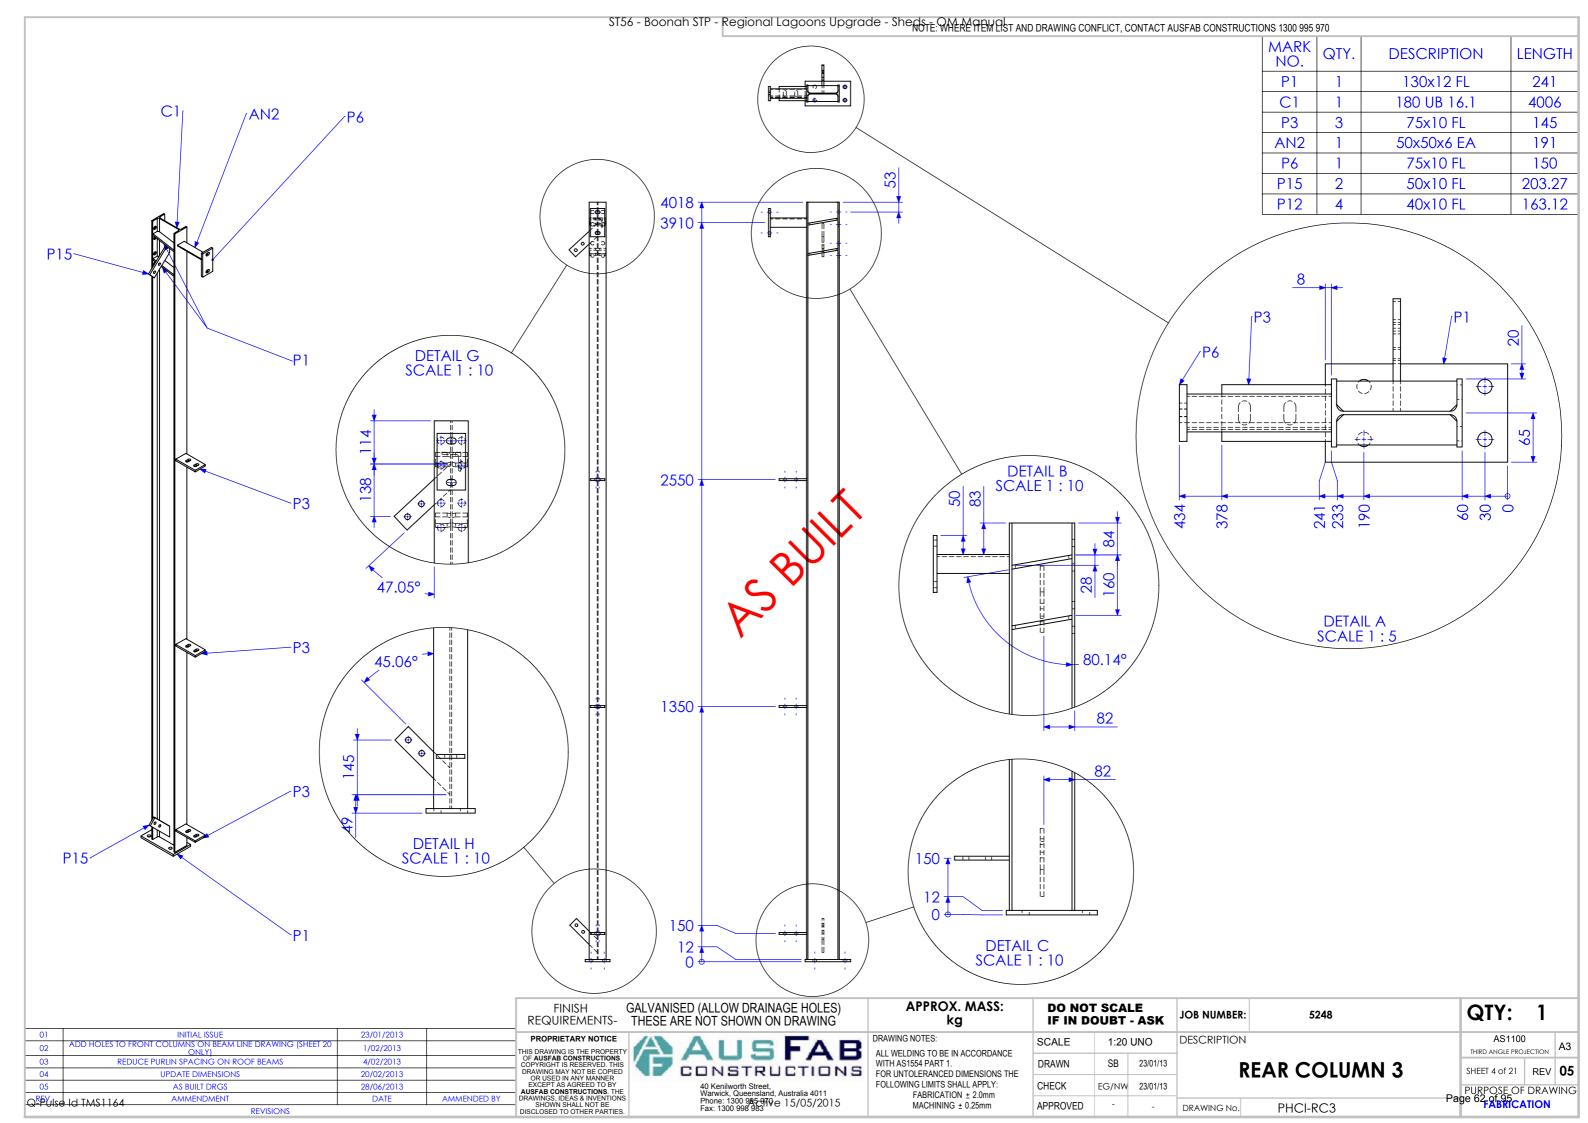
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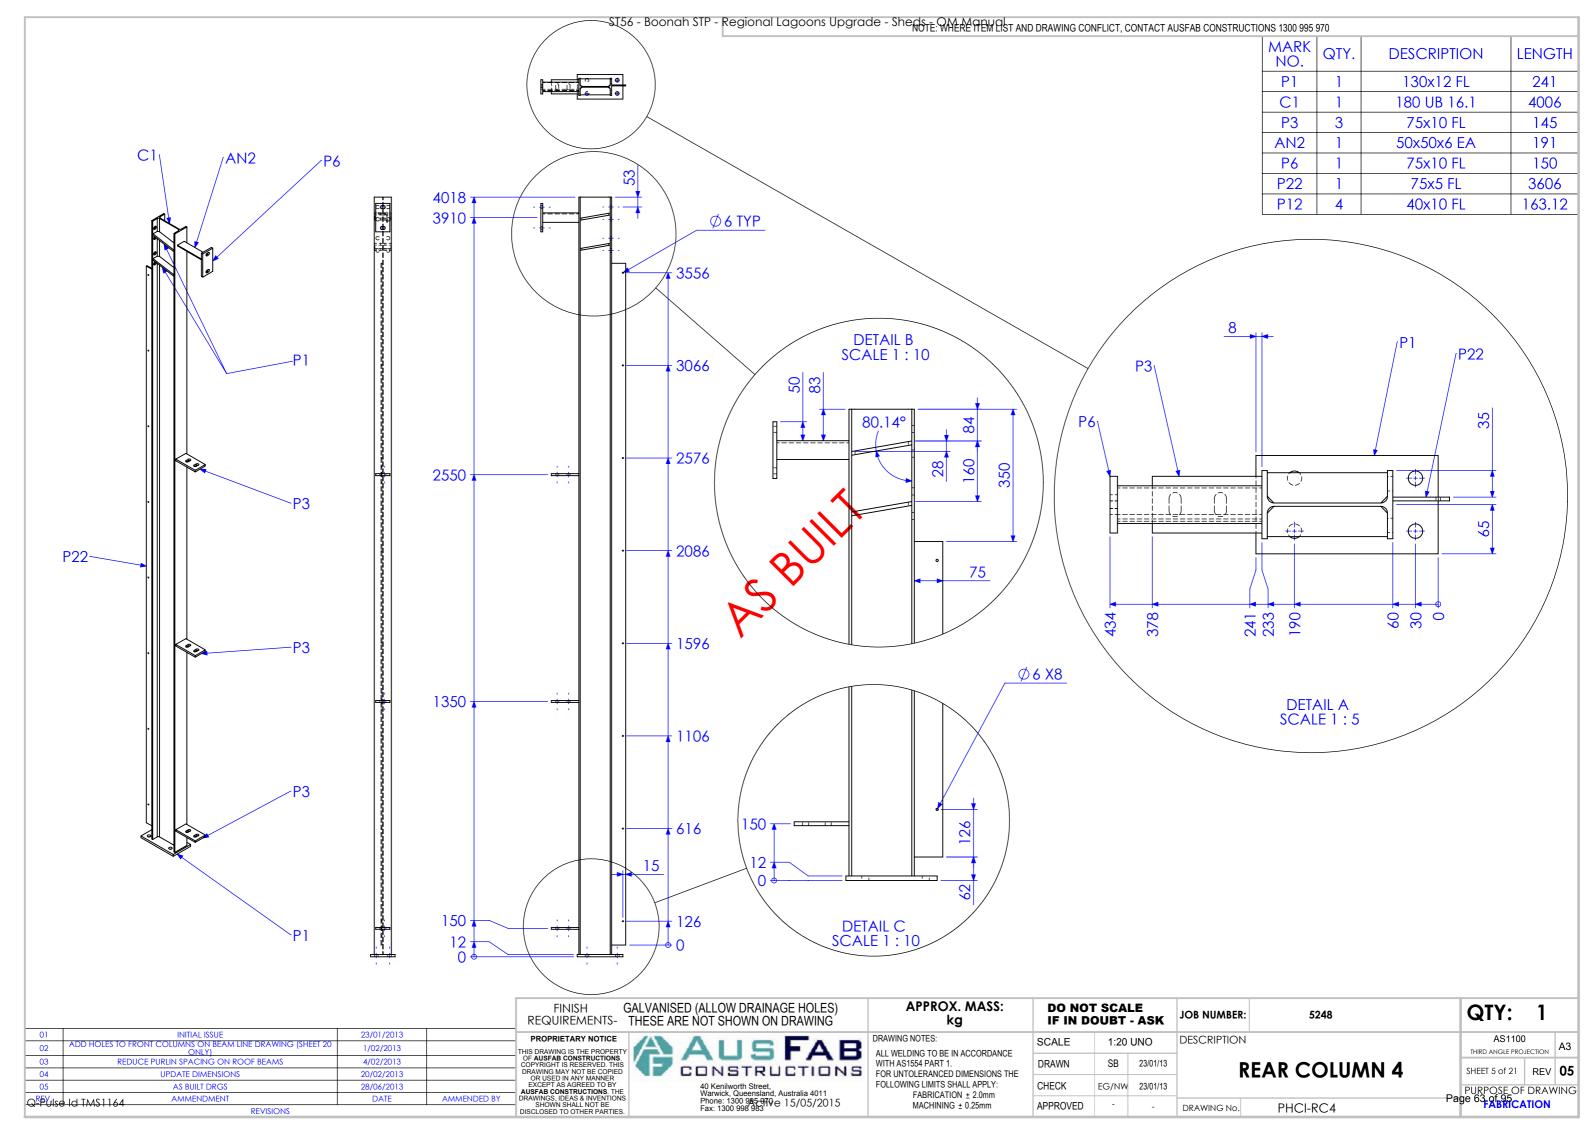
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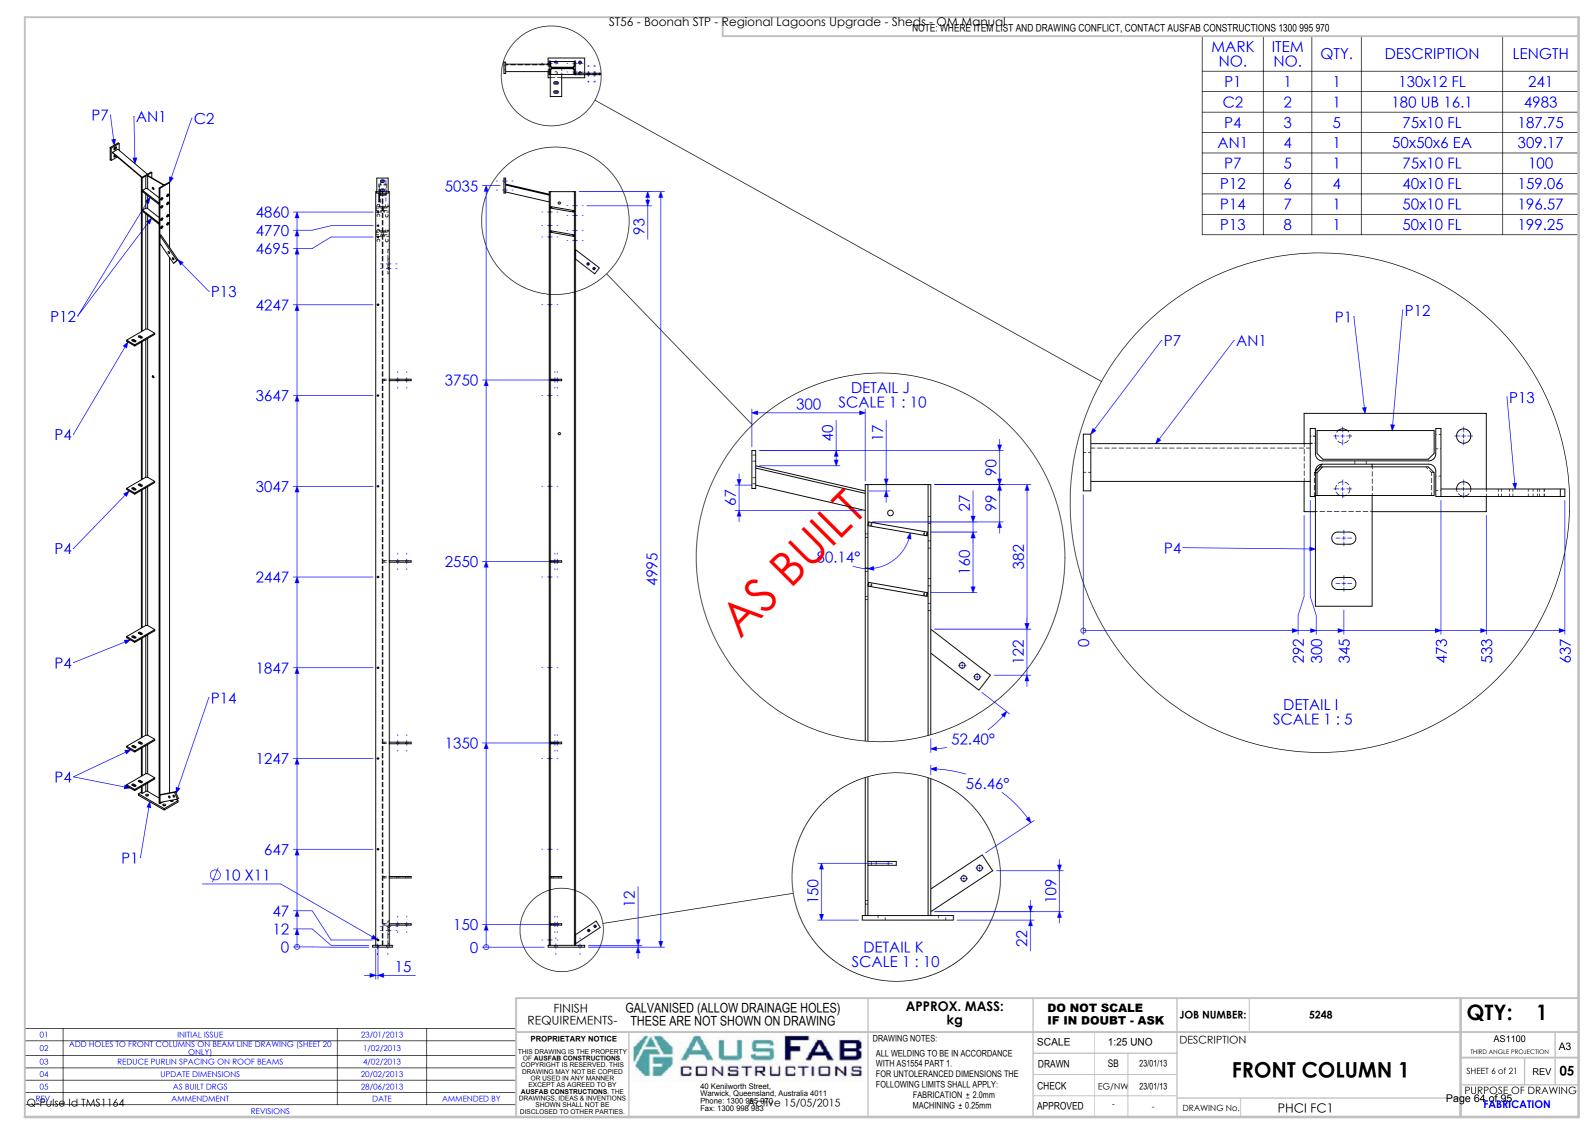


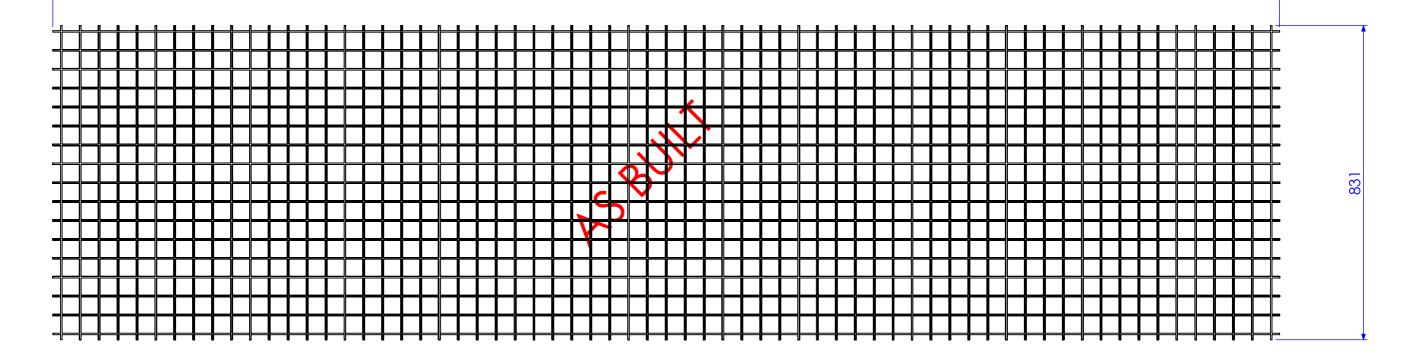











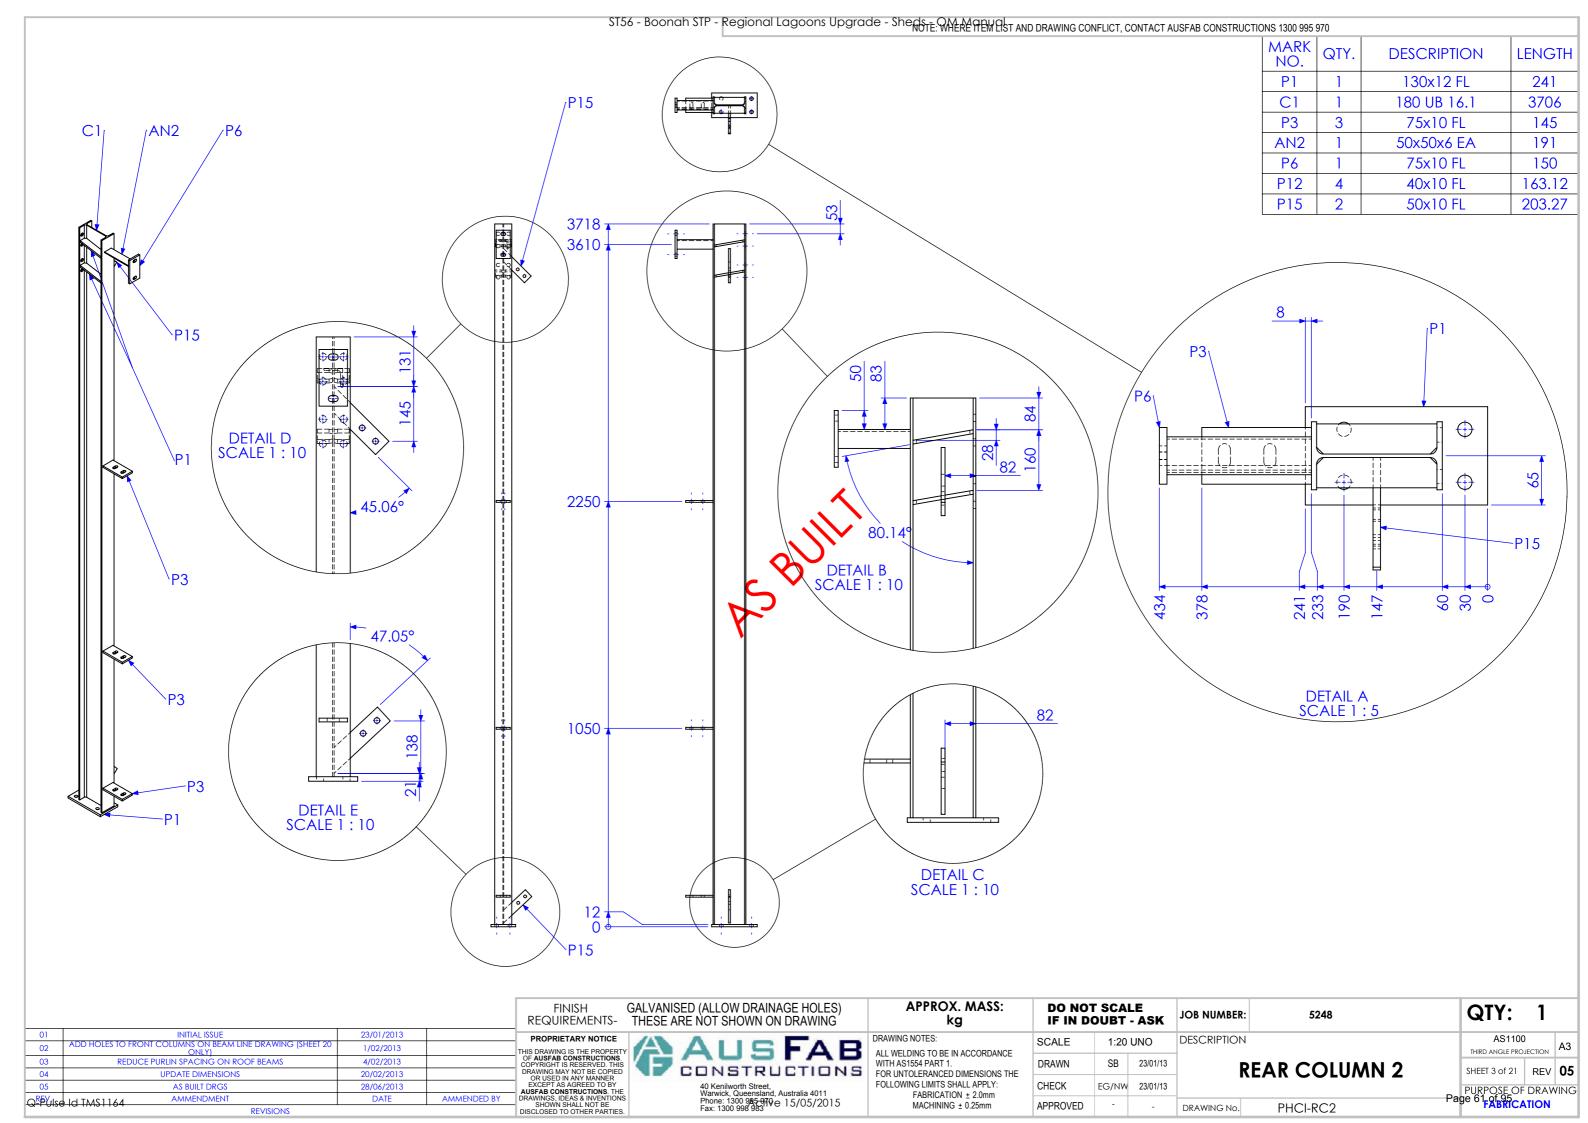


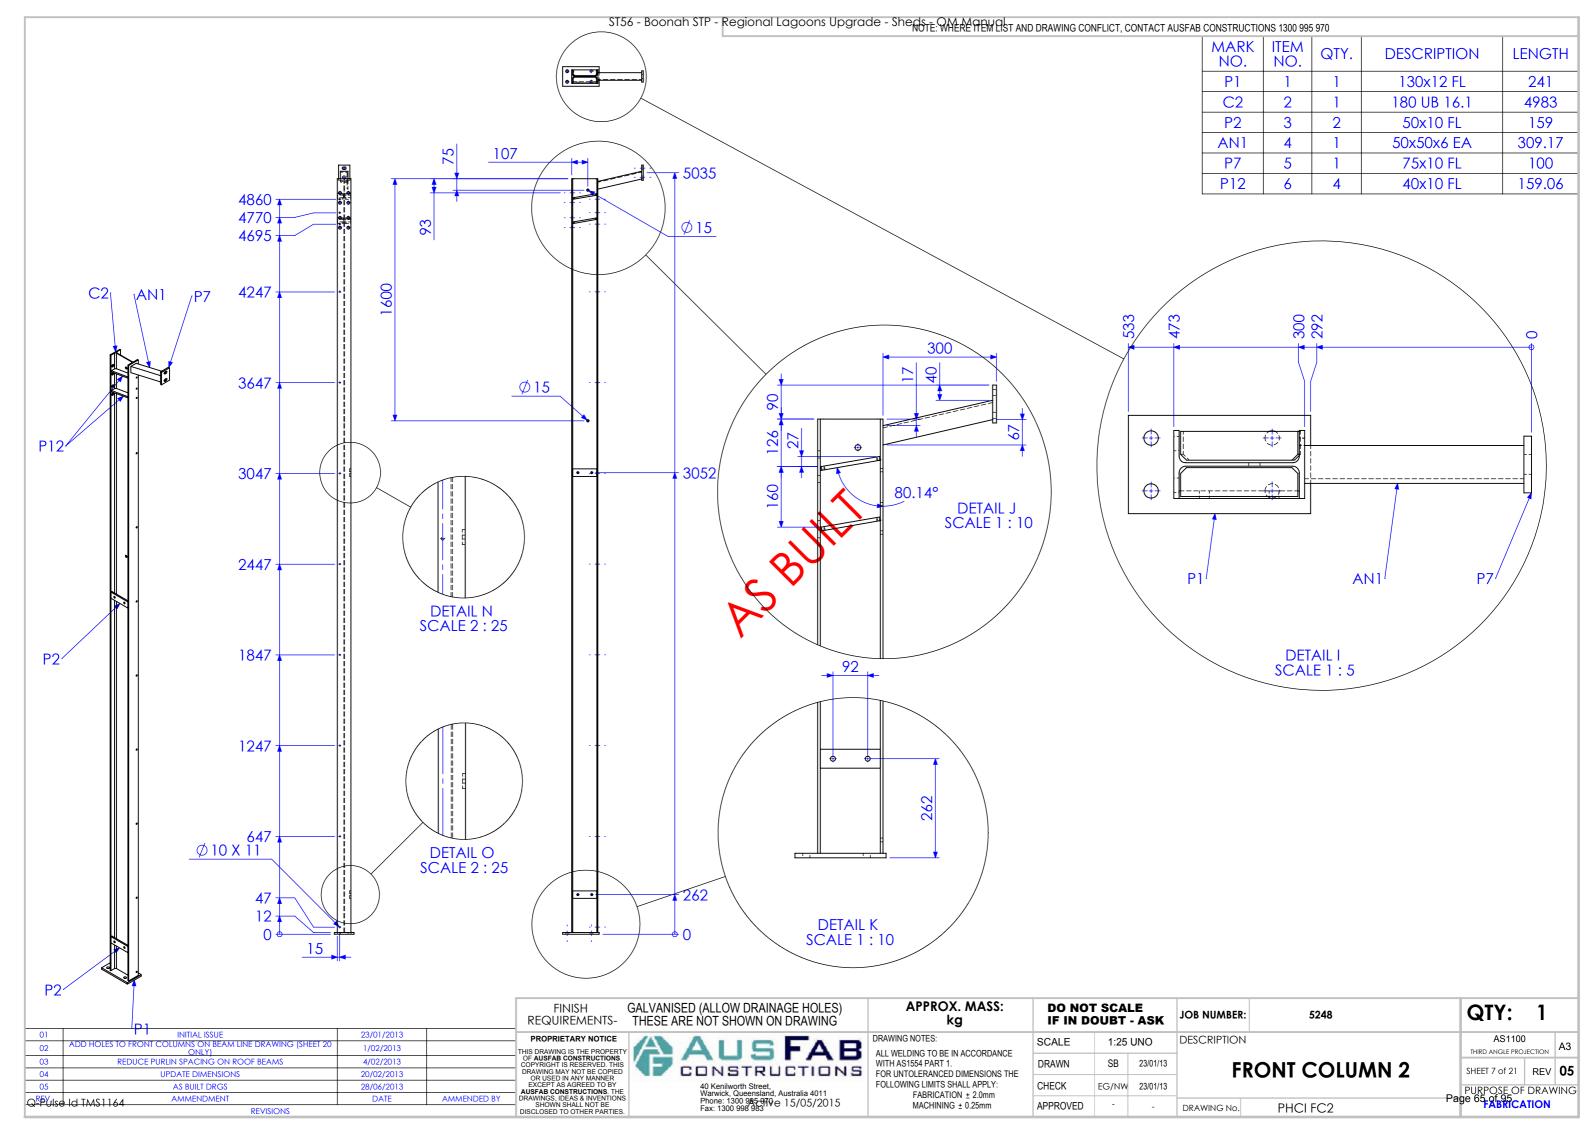


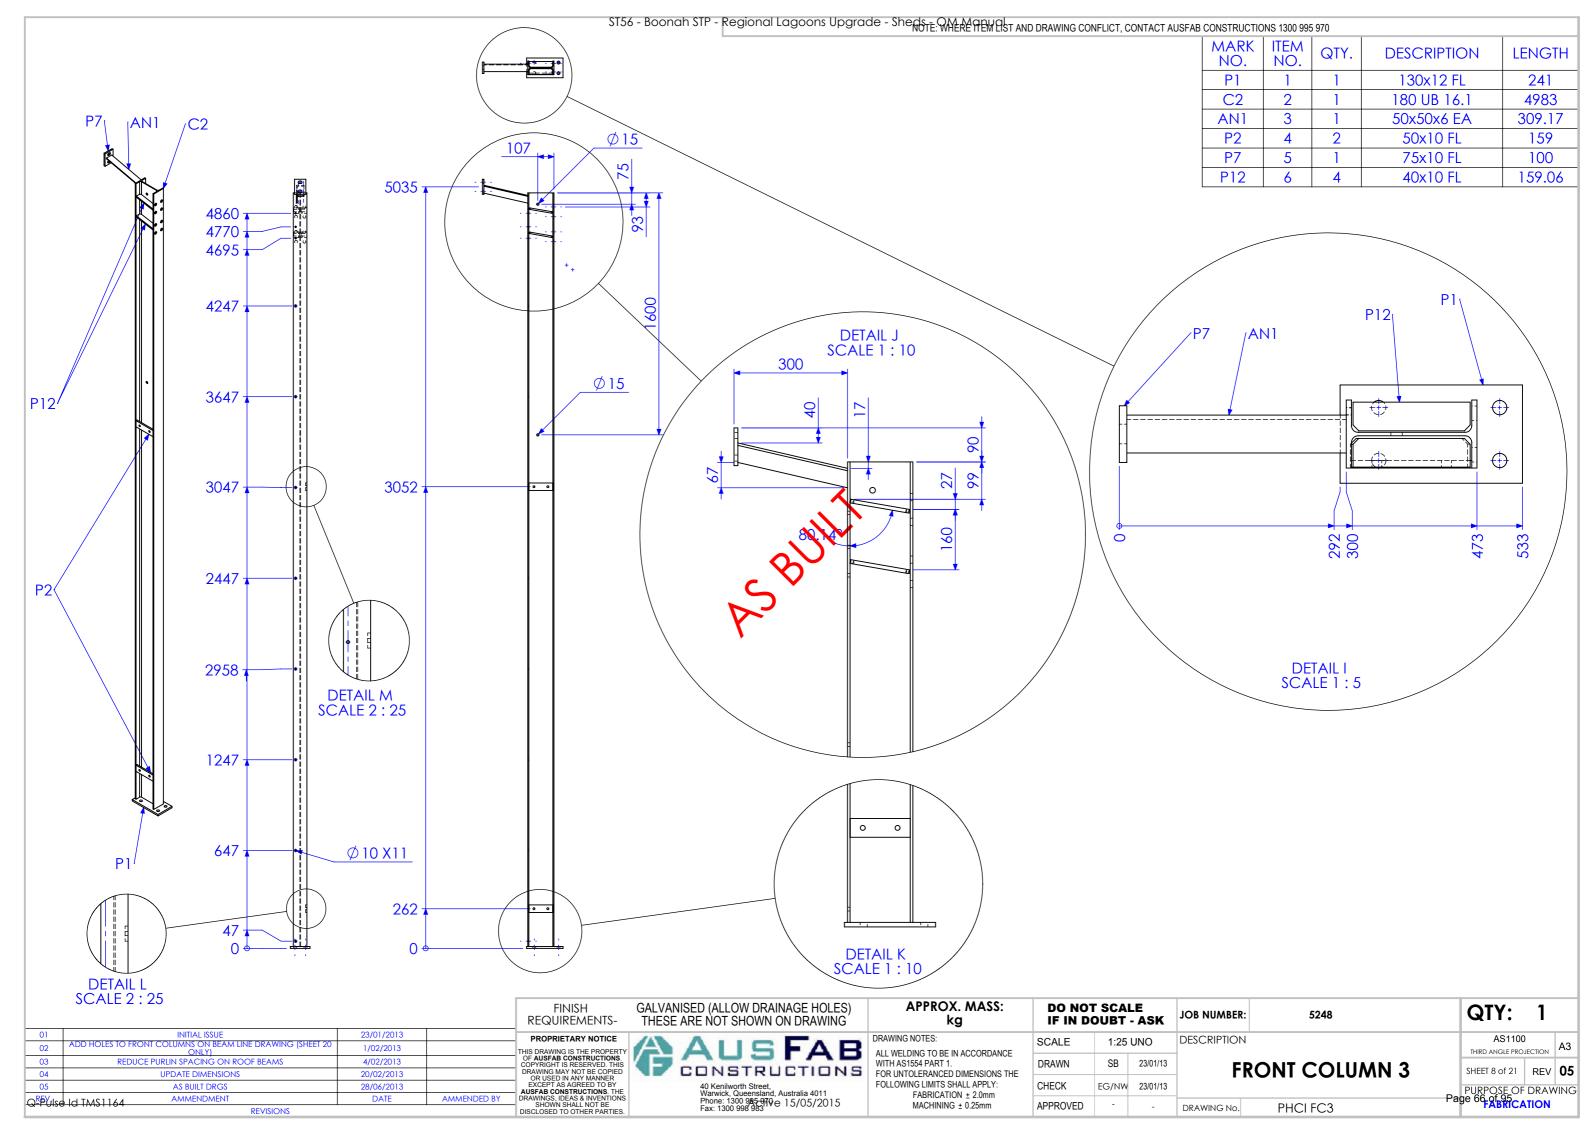


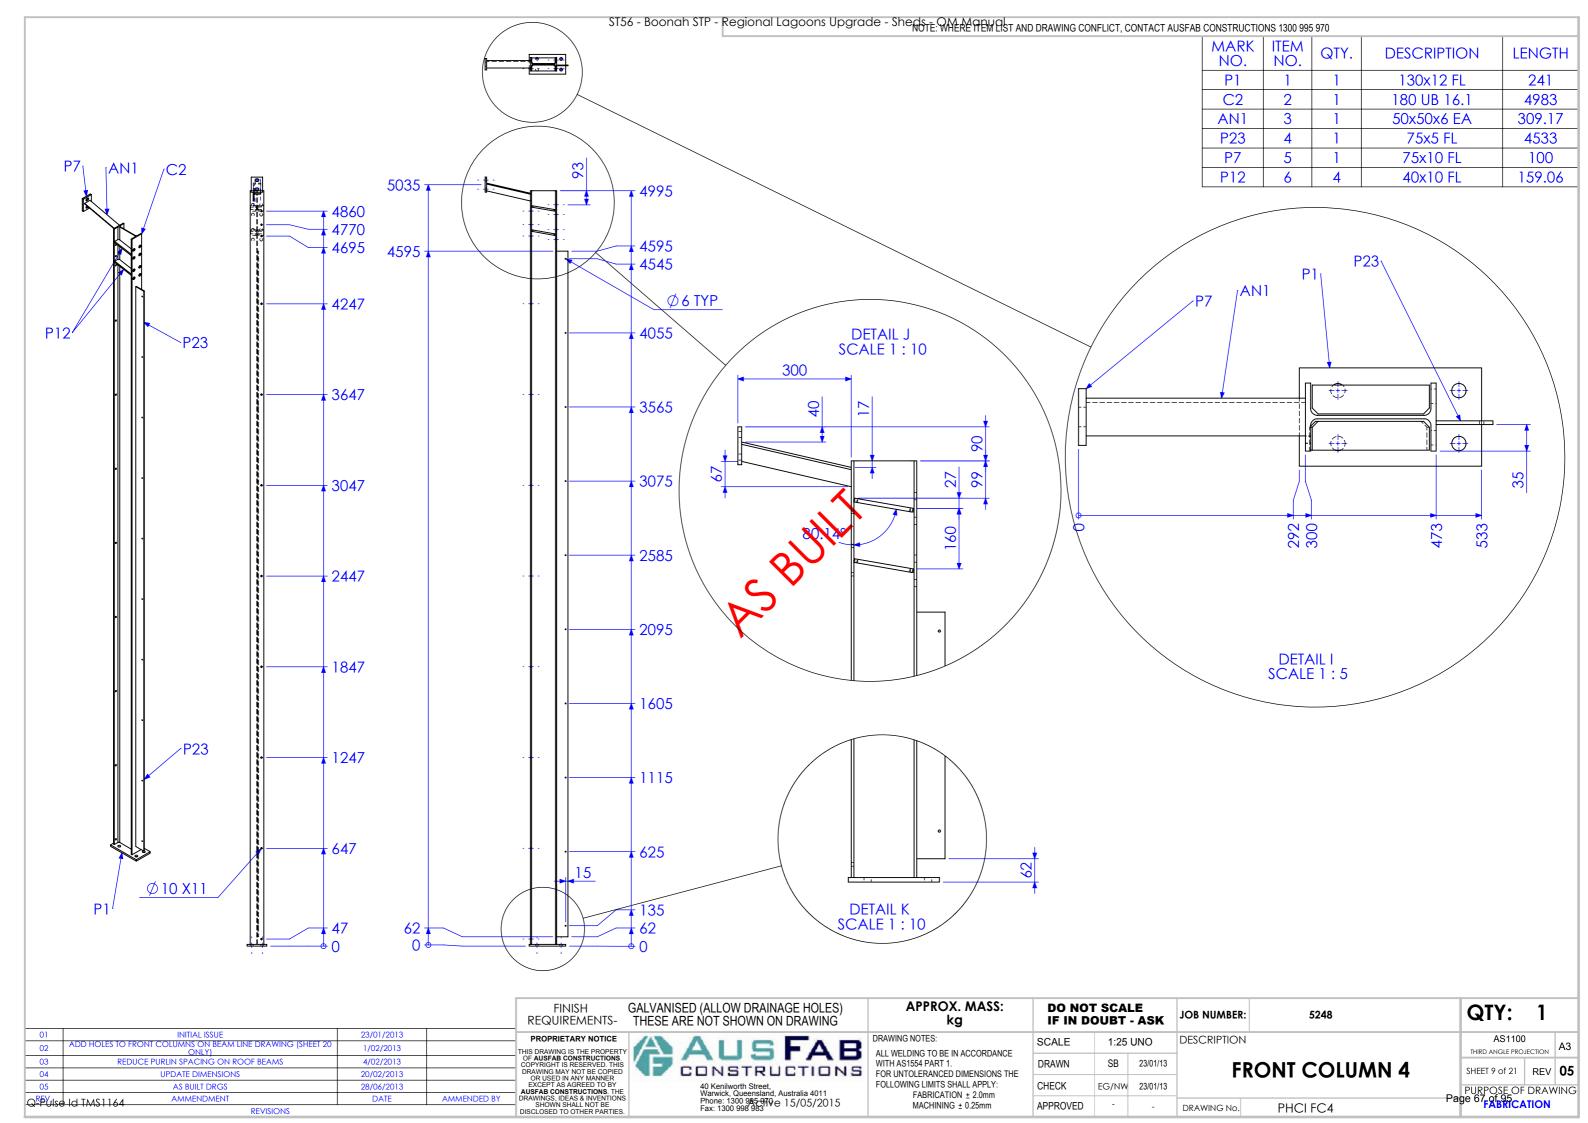


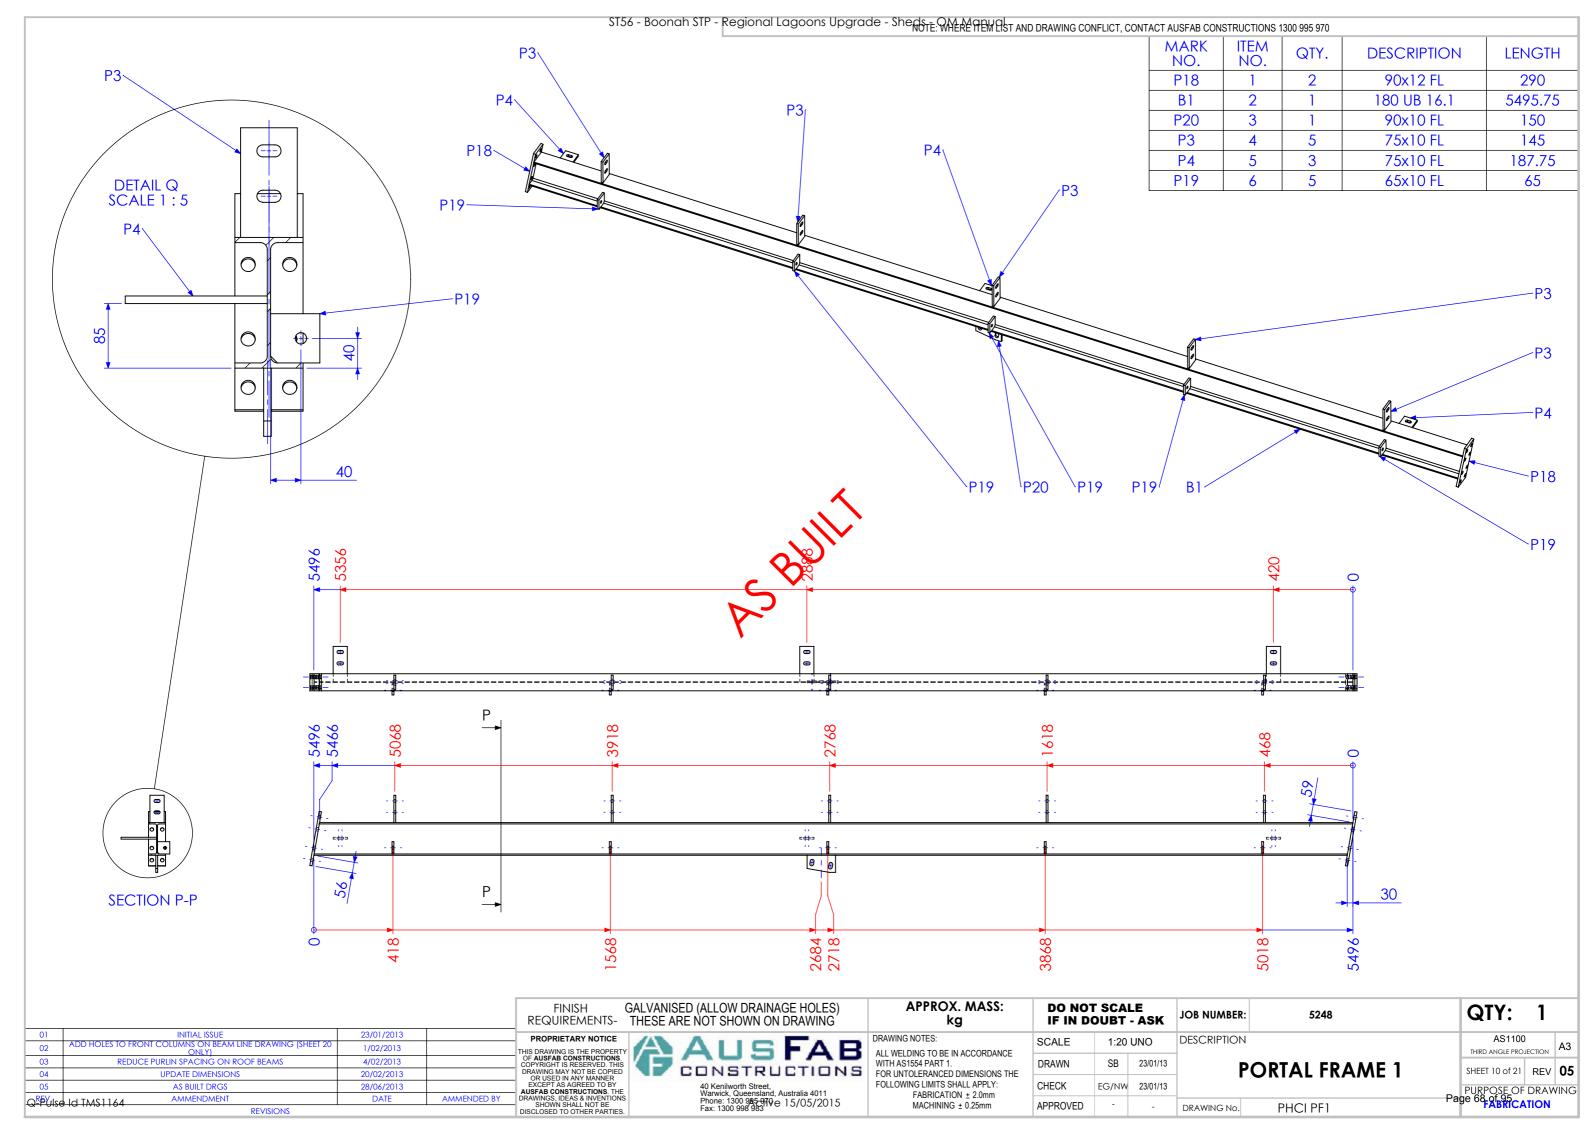

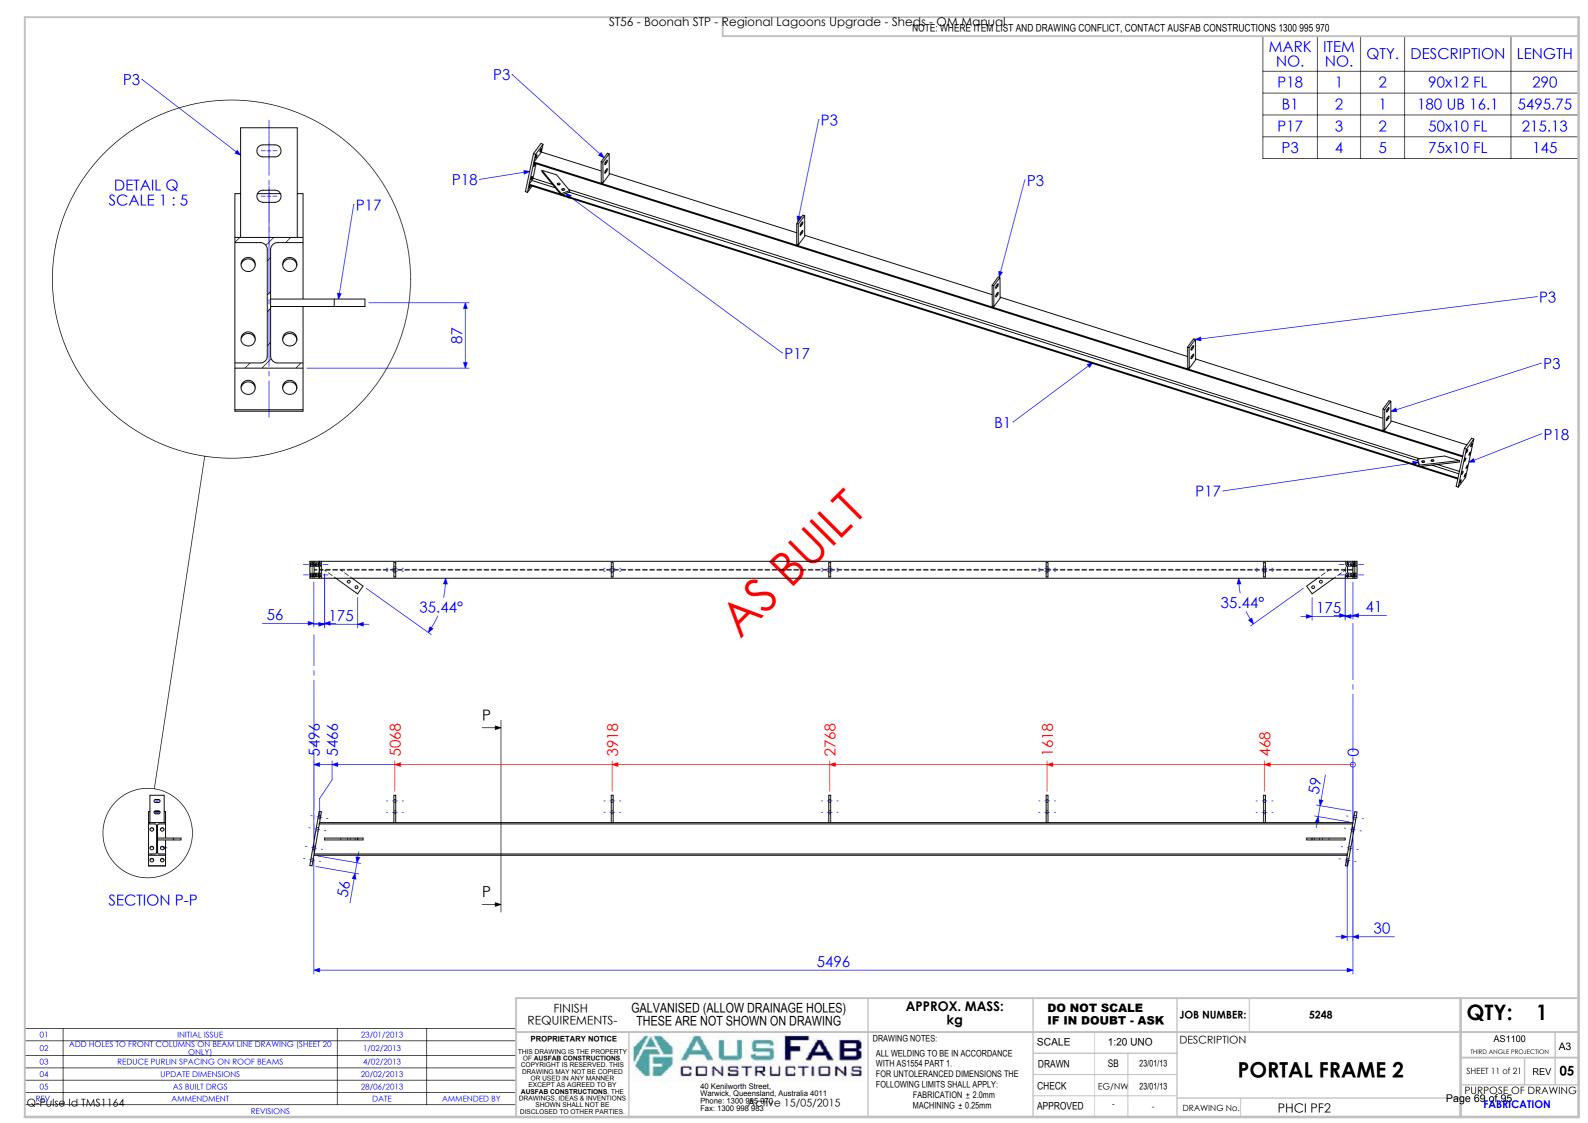


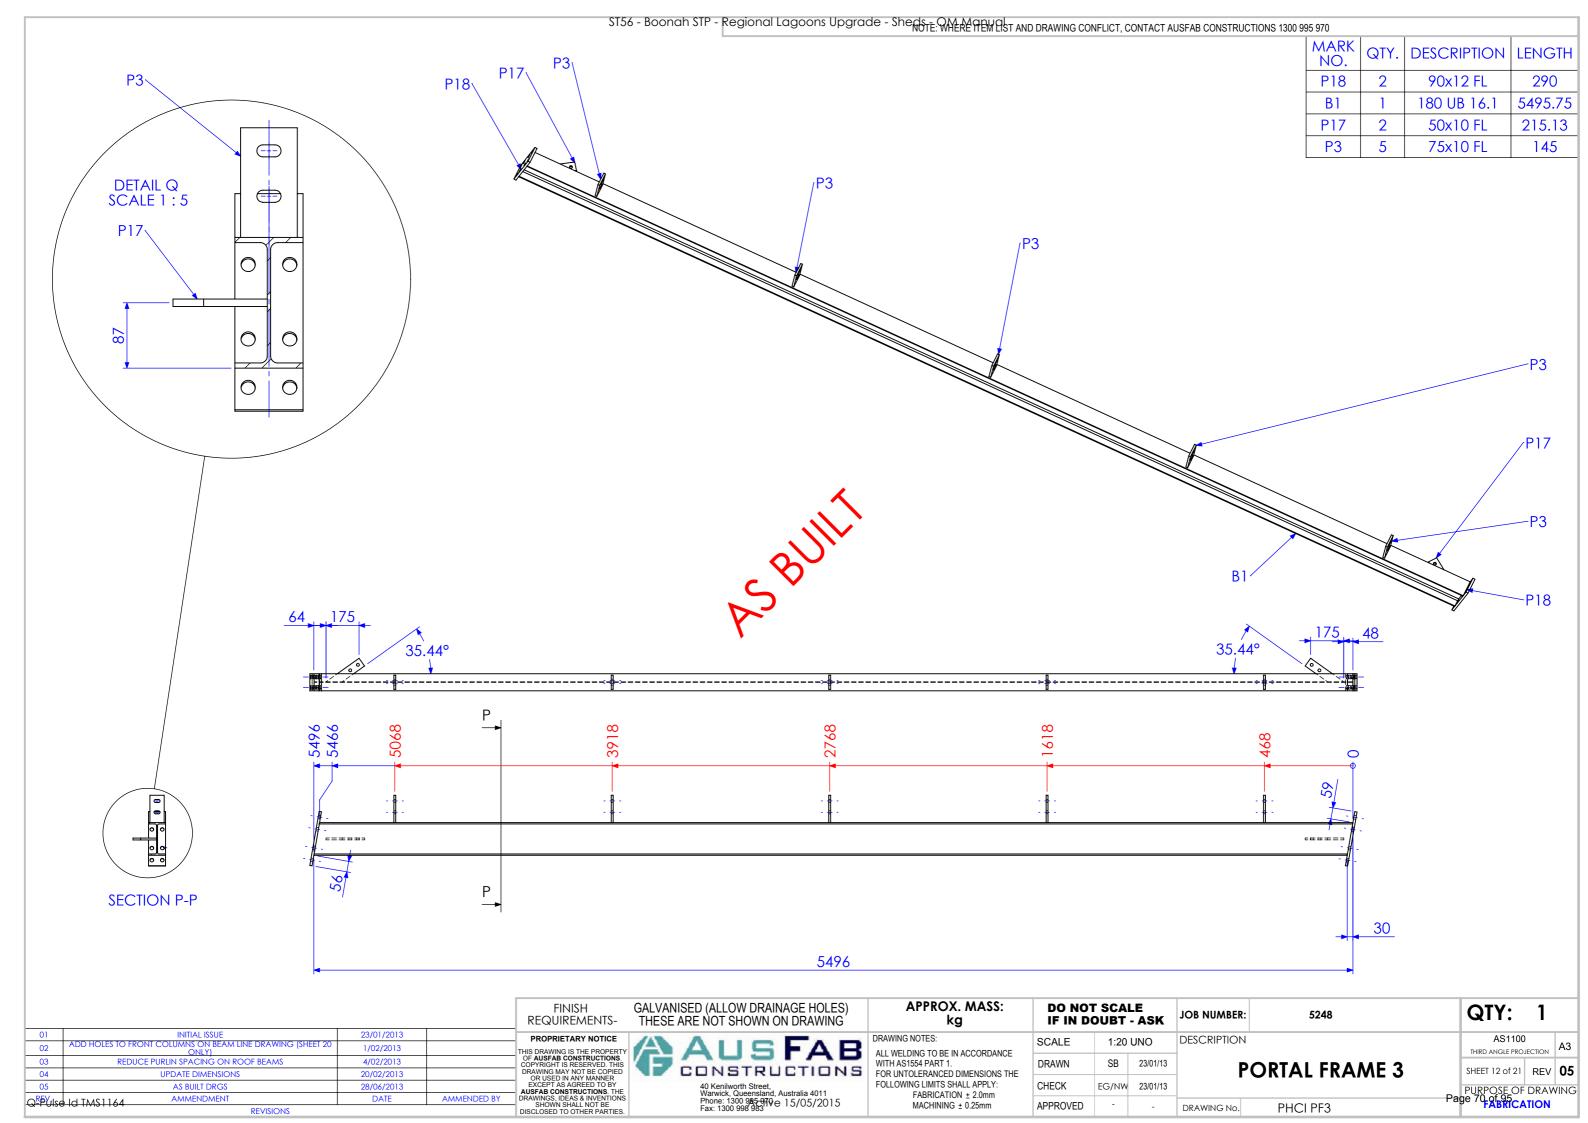

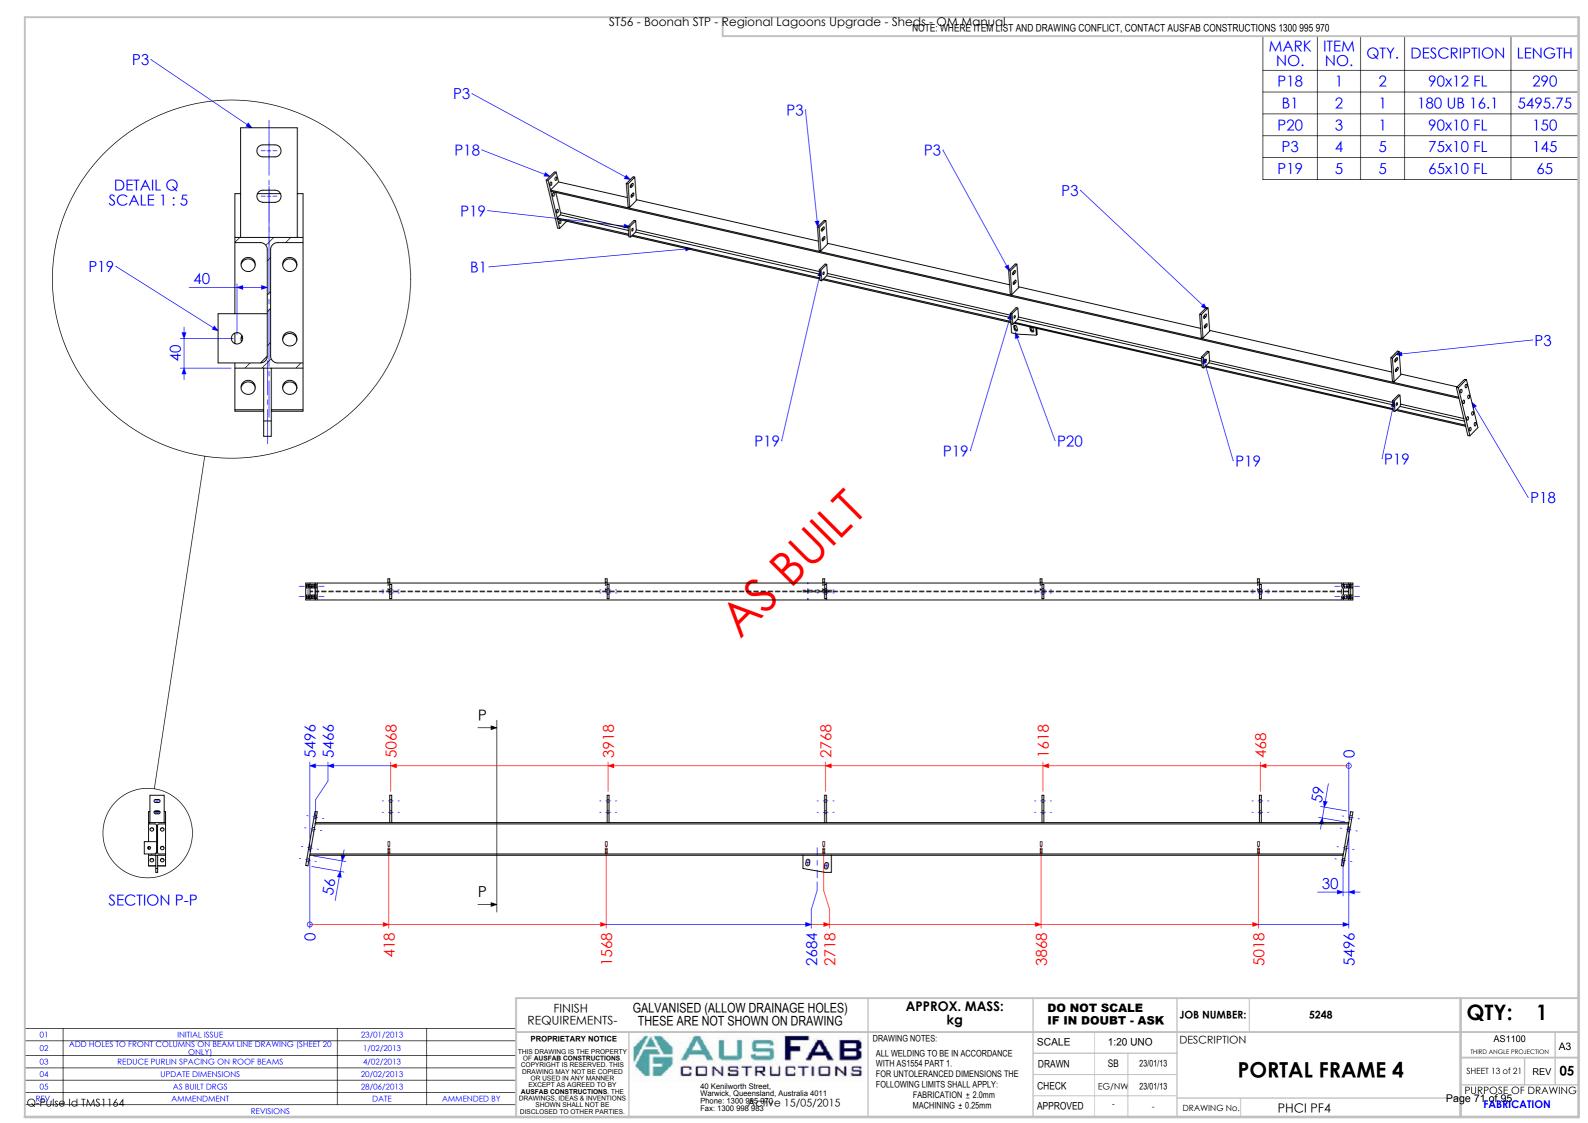

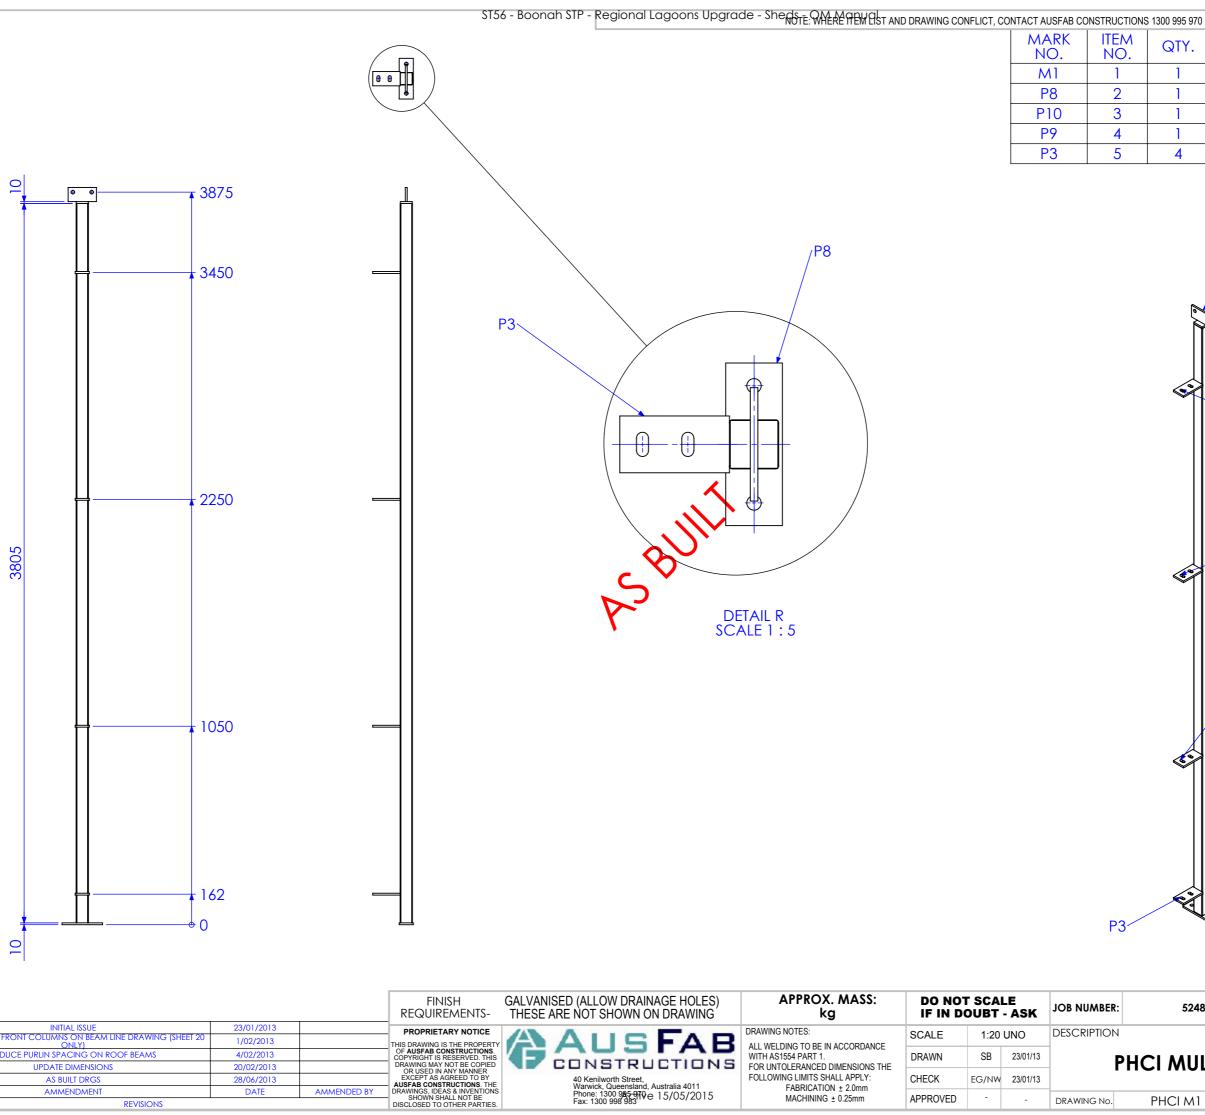

00	SONTACT ACCUME CONCINCO TICKO 1000 330 370									
	MARK NO.	ITEM NO.	QTY.	DESCRIPTION	LENGTH					
	M1	1	1	65x65x2 SHS	3805.03					
	P8	2	1	75x10 FL	215					
	P10	3	1	10MM CAP PLATE	63 X 63					
	P9	P9 4		9 4 1		75x10 FL	150			
	P3	5	4	75x10 FL	145					

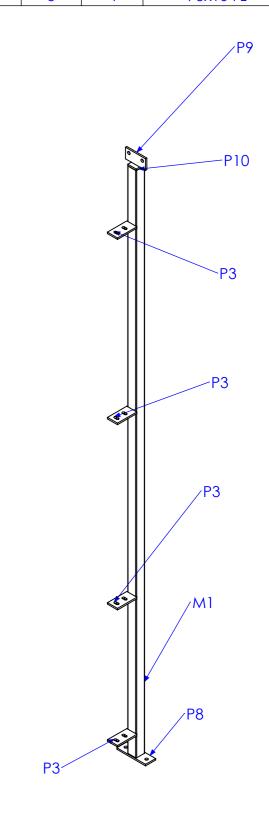

01	INITIAL ISSUE	23/01/2013	
02	ADD HOLES TO FRONT COLUMNS ON BEAM LINE DRAWING (SHEET 20 ONLY)	1/02/2013	
03	REDUCE PURLIN SPACING ON ROOF BEAMS	4/02/2013	
04	UPDATE DIMENSIONS	20/02/2013	
05	AS BUILT DRGS	28/06/2013	
Ω <u>R</u> EYılse	Id TMS1164 AMMENDMENT	DATE	AMMENDED BY
Q 1 013C	714 1110 110 1		

FAB

ALL WELDING TO BE IN ACCORDANCE WITH AS1554 PART 1. WITH AS1554 PAR1 1.

FOR UNTOLERANCED DIMENSIONS THE FOLLOWING LIMITS SHALL APPLY:
FABRICATION ± 2.0mm
MACHINING ± 0.25mm

SCALE 1:20 UNO DRAWN SB 23/01/13 CHECK EG/NW 23/01/13 APPROVED


DESCRIPTION **PHCI MULLION 1**

PHCI M1

5248


JOB NUMBER:

QTY: 2 THIRD ANGLE PROJECTION A3 SHEET 14 of 21 REV **05** PURPOSE OF DRAWING Page 72 of 95 CATION

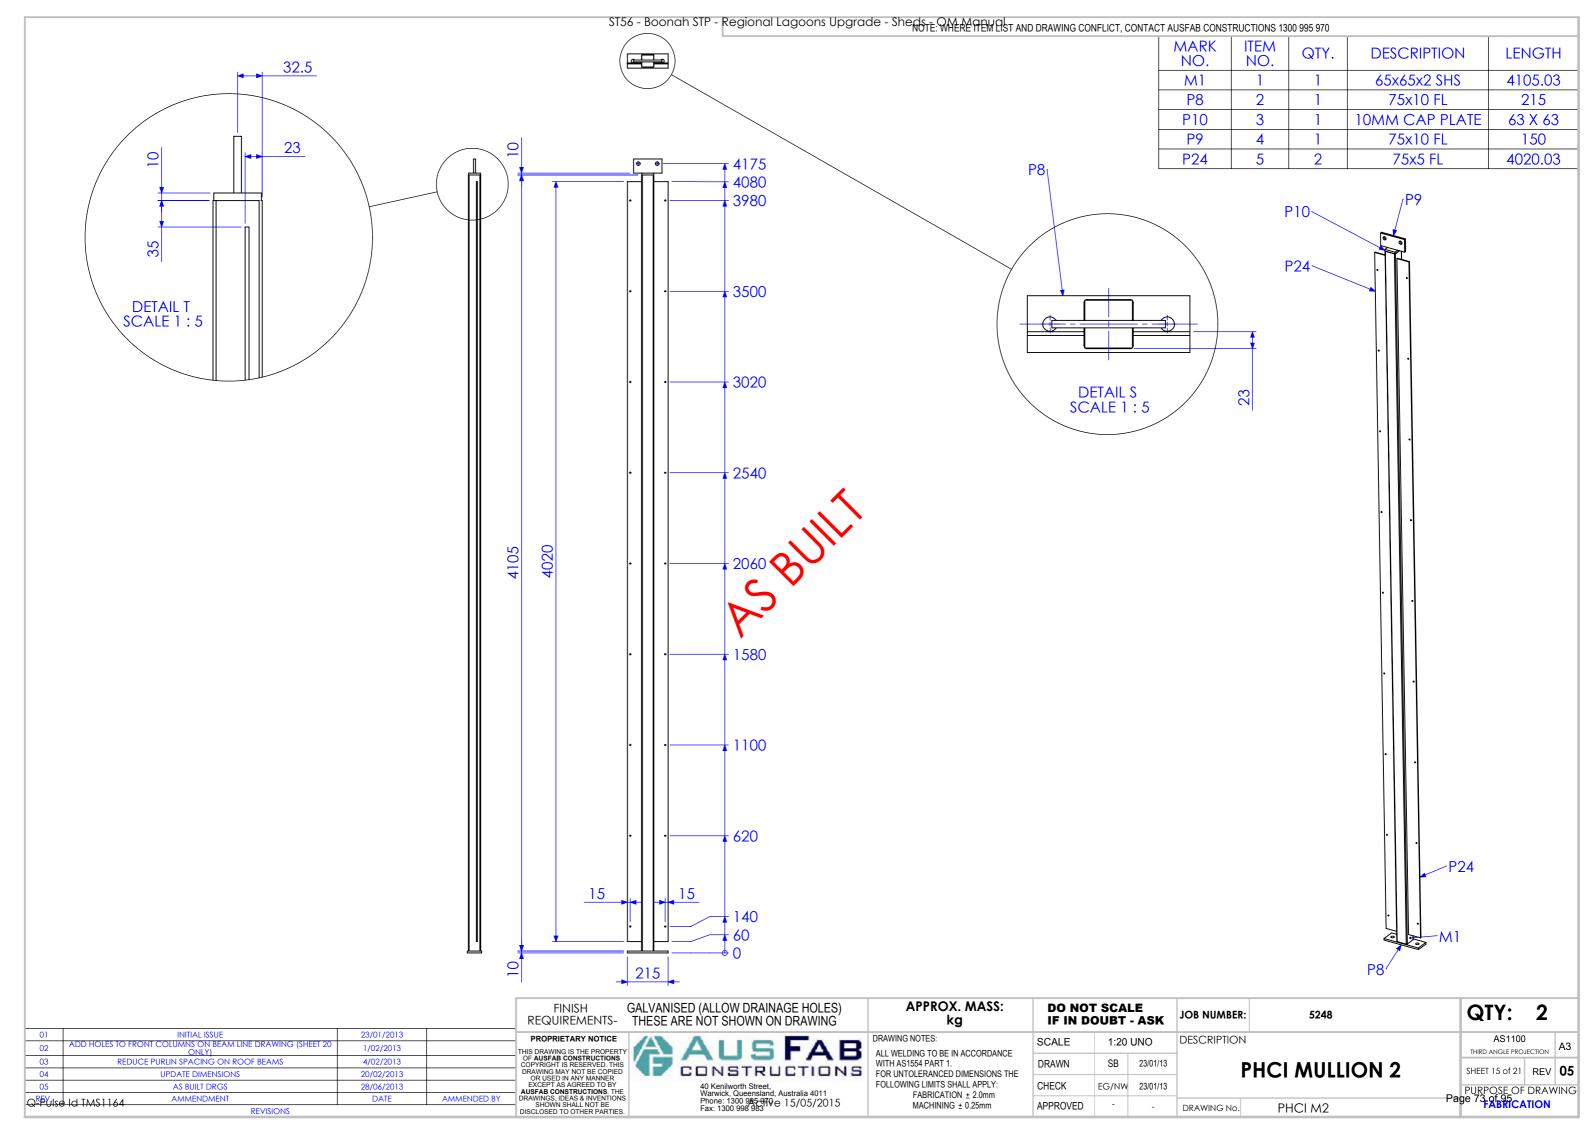

ST56 - Boonah STP - Regional Lagoons Upgrade - Sheds OM Manual AND DRAWING CONFLICT, CONTACT AUSFAB CONSTRUCTIONS 1300 995 970

MARK NO.	DESCRIPTION	LENGTH
MCB 1	32x5 FL	4690

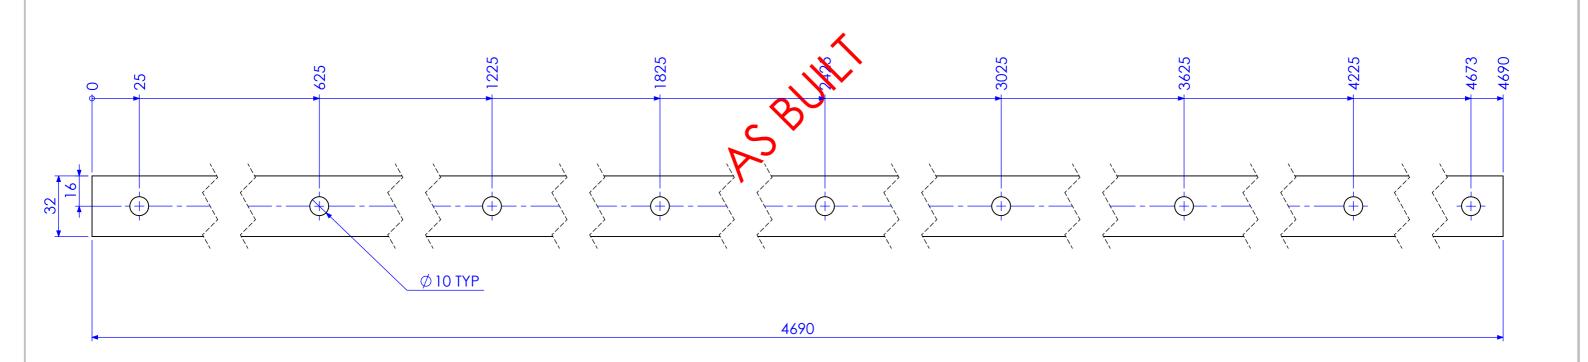

INITIAL ISSUE
COLUMNS ON BEAM LINE DRAWING (SH 23/01/2013 03 04 05 4/02/2013 REDUCE PURLIN SPACING ON ROOF BEAMS 20/02/2013 UPDATE DIMENSIONS 28/06/2013 DATE AS BUILT DRGS QPFUISE ID TMS1164 AMMENDMENT AMMENDED BY

FINISH REQUIREMENTS-PROPRIETARY NOTICE THIS DRAWING IS THE PROPERTY
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SHOWN SHALL NOT BE
DISCLOSED TO OTHER PARTIES.

GALVANISED (ALLOW DRAINAGE HOLES) THESE ARE NOT SHOWN ON DRAWING

DRAWING NOTES: FAB CONSTRUCTIONS

DO NOT SCALE IF IN DOUBT - ASK kg SCALE ALL WELDING TO BE IN ACCORDANCE DRAWN SB FOR UNTOLERANCED DIMENSIONS THE FOLLOWING LIMITS SHALL APPLY: FABRICATION ± 2.0mm MACHINING ± 0.25mm CHECK APPROVED

APPROX. MASS:

1:2 UNO 23/01/13 EG/NW 23/01/13

JOB NUMBER:

DESCRIPTION **MESH CLAMP BAR 1**

5248

QTY: THIRD ANGLE PROJECTION A3 SHEET 16 of 21 | REV | **05** PURPOSE OF DRAWING Page 74 of 95 FABRICATION

40 Kenilworth Street, Warwick, Queensland, Australia 4011 Phone: 1300 985-970 e 15/05/2015 Fax: 1300 998 983

MCB 1 DRAWING No.

ST56 - Boonah STP - Regional Lagoons Upgrade - Sheds OM Manual And DRAWING CONFLICT, CONTACT AUSFAB CONSTRUCTIONS 1300 995 970


MARK NO.	DESCRIPTION	LENGTH
MCB 2	32x5 FL	120

QTY: 4


BAR 2


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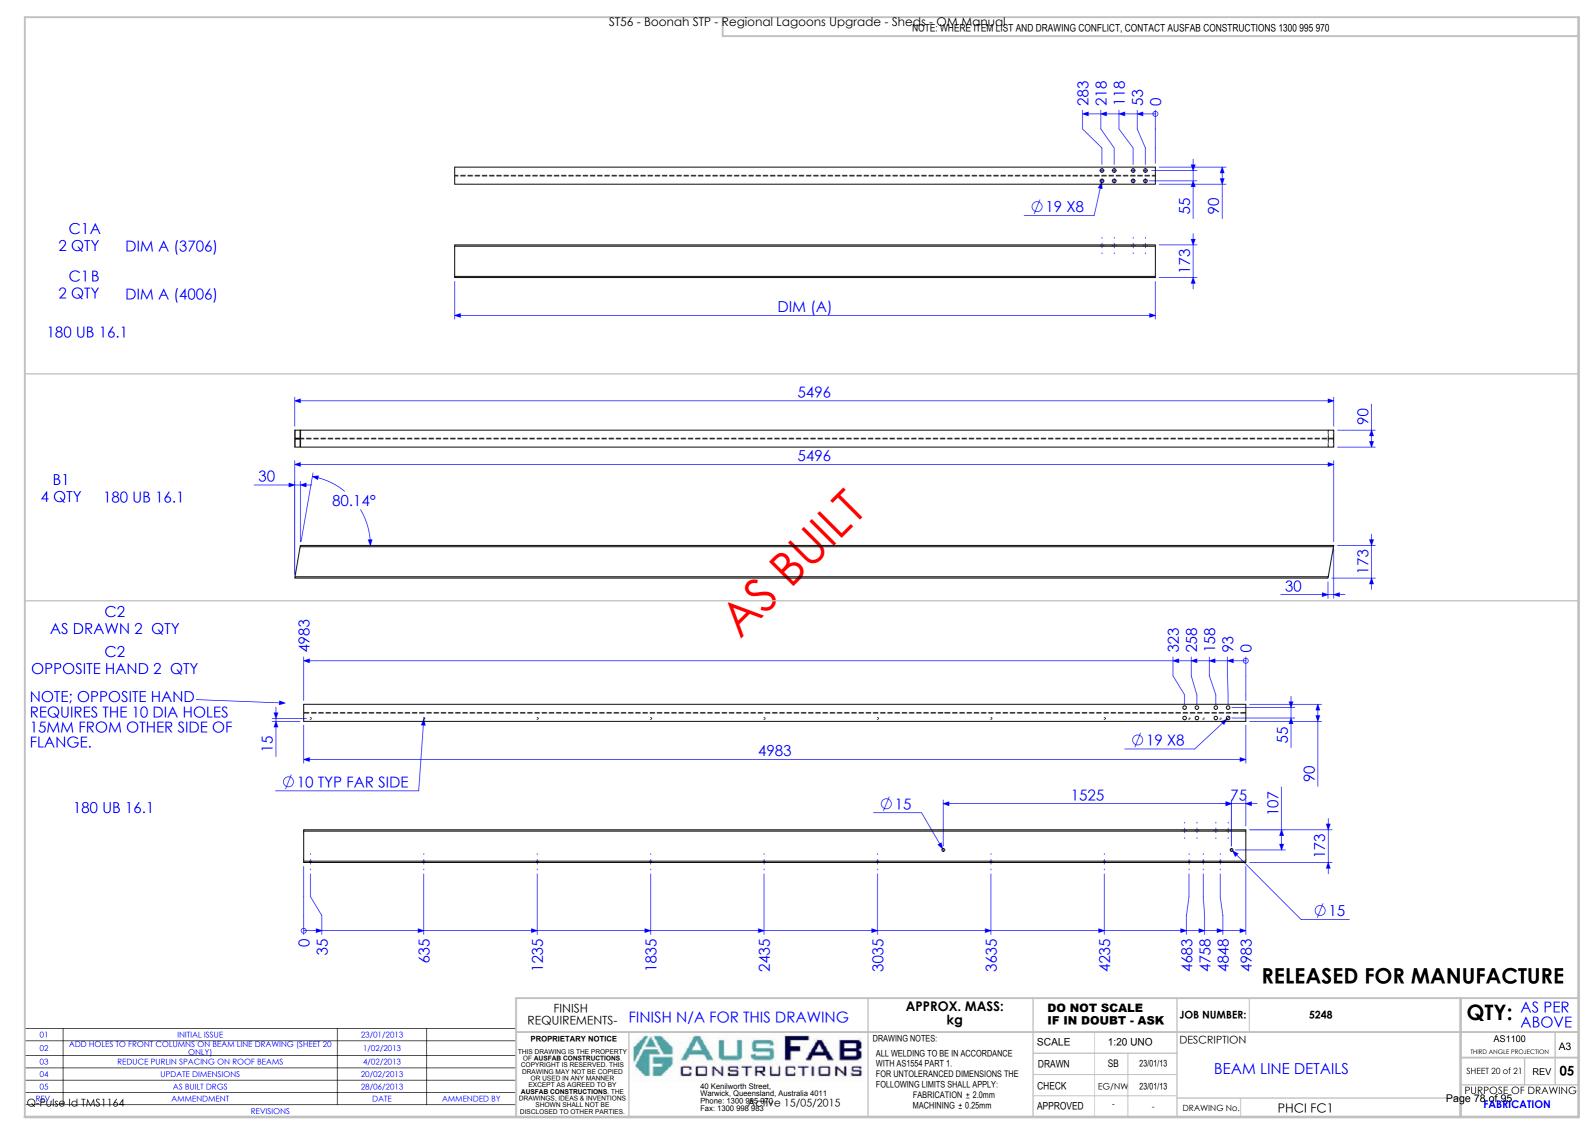
SHEET 17 of 21 REV 05
PURPOSE OF DRAWING
Page 75-05-05-CATION

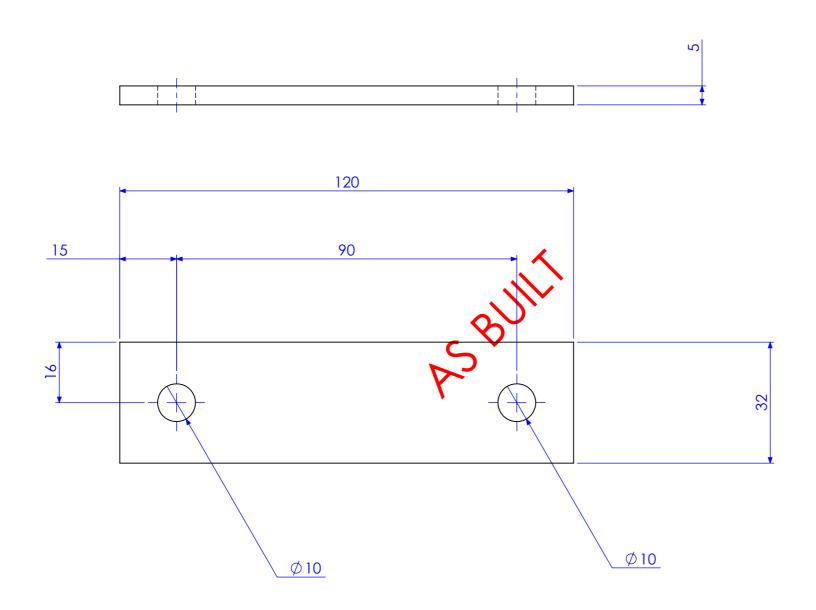



					FINISH REQUIREMENTS-	GALVANISED (ALLOW DRAINAGE HOLES) THESE ARE NOT SHOWN ON DRAWING	APPROX. MASS: kg	DO NOT			JOB NUMBER	5248
	01	INITIAL ISSUE	23/01/2013		PROPRIETARY NOTICE	//>	DRAWING NOTES:	CCALE	1.50	LINIO	DESCRIPTION	1
	02	ADD HOLES TO FRONT COLUMNS ON BEAM LINE DRAWING (SHEET 20 ONLY)	1/02/2013		THIS DRAWING IS THE PROPERTY	ALISFAR	ALL WELDING TO BE IN ACCORDANCE	SCALE	1:50	UNO	DESCRIPTION	•
	03	REDUCE PURLIN SPACING ON ROOF BEAMS	4/02/2013		OF AUSFAB CONSTRUCTIONS. COPYRIGHT IS RESERVED. THIS		WITH AS1554 PART 1.	DRAWN	SB	23/01/13	8.81	ECH CLAAAD I
	04	UPDATE DIMENSIONS	20/02/2013		DRAWING MAY NOT BE COPIED OR USED IN ANY MANNER	CONSTRUCTIONS	FOR UNTOLERANCED DIMENSIONS THE				/ // \	ESH CLAMP I
	05	AS BUILT DRGS	28/06/2013		EXCEPT AS AGREED TO BY AUSFAB CONSTRUCTIONS. THE	40 Kenilworth Street, Warwick, Queensland, Australia 4011	FOLLOWING LIMITS SHALL APPLY:	CHECK	EG/NW	23/01/13		
1 1	⊃ <mark>R</mark> EV _{ils} a	Id TMS1164 AMMENDMENT	DATE	AMMENDED BY	DRAWINGS, IDEAS & INVENTIONS SHOWN SHALL NOT BE	Phone: 1300 985-970 \(\text{15} \) 15/\(\text{15} \) 15	FABRICATION ± 2.0mm	4 DDD 01 /FD				
	x-ı UI30	REVISIONS		•	DISCLOSED TO OTHER PARTIES.	Phone: 1300 985 970 e 15/05/2015 Fax: 1300 998 983	MACHINING ± 0.25mm	APPROVED	-	-	DRAWING No.	MCB 2




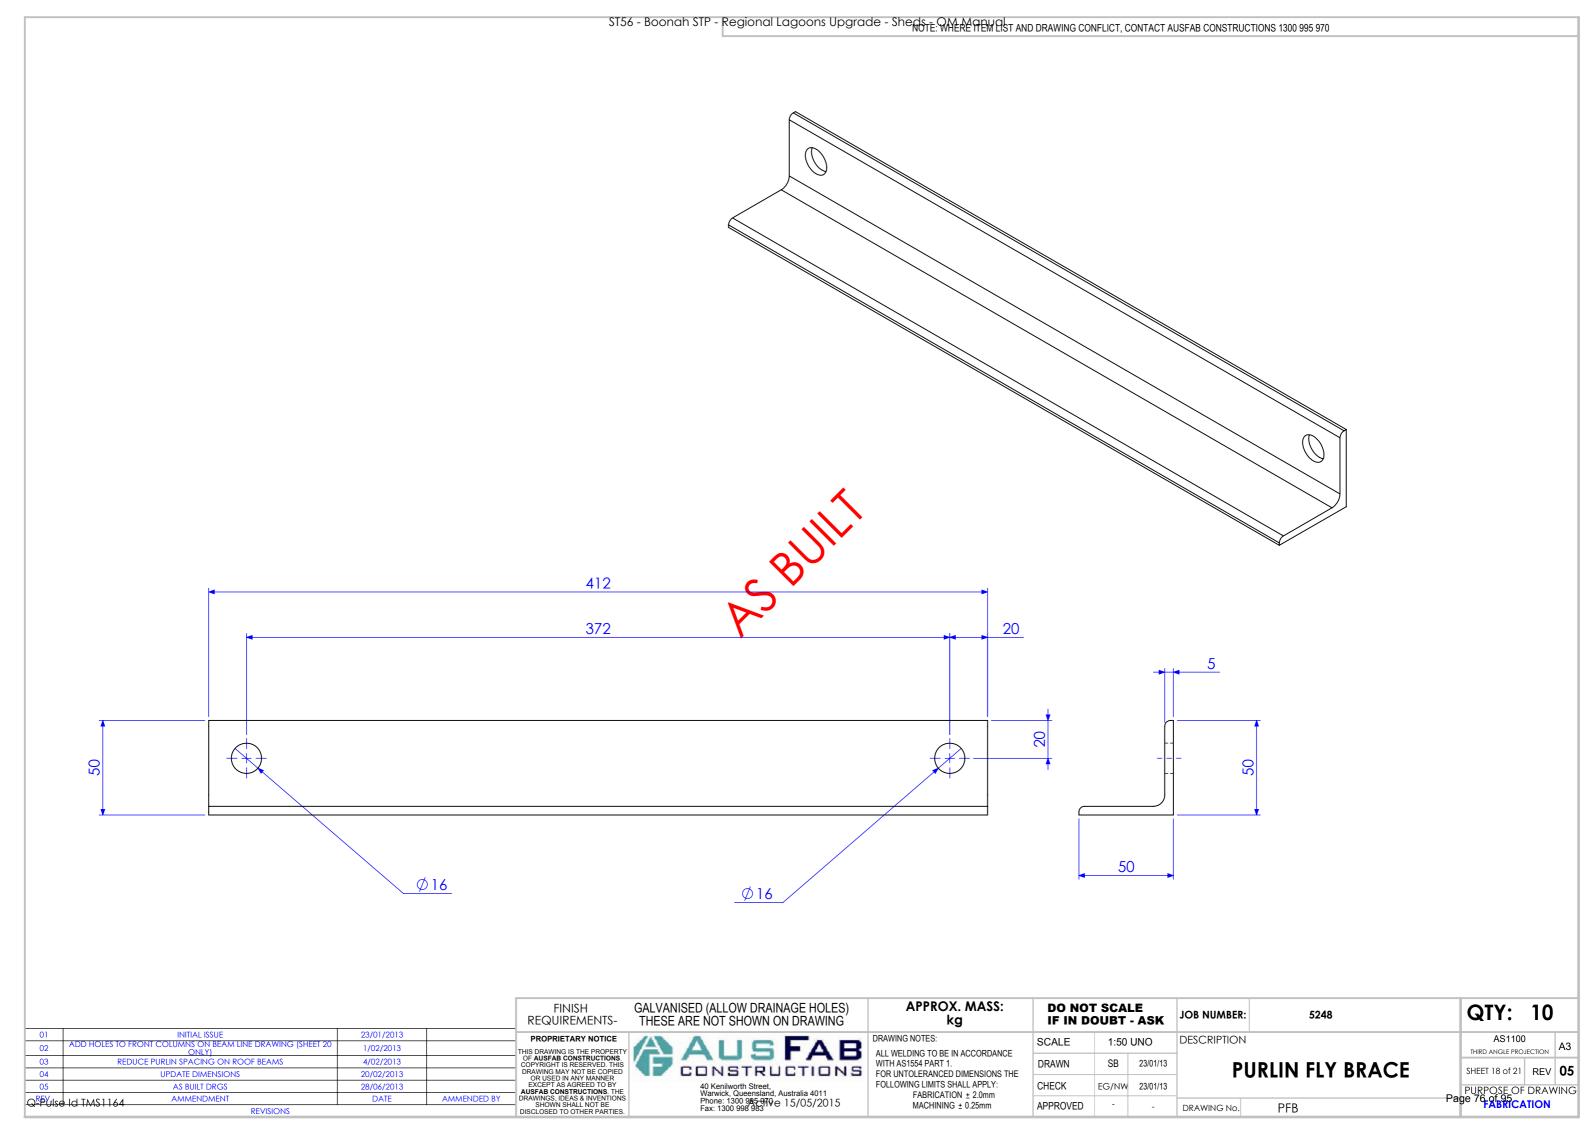


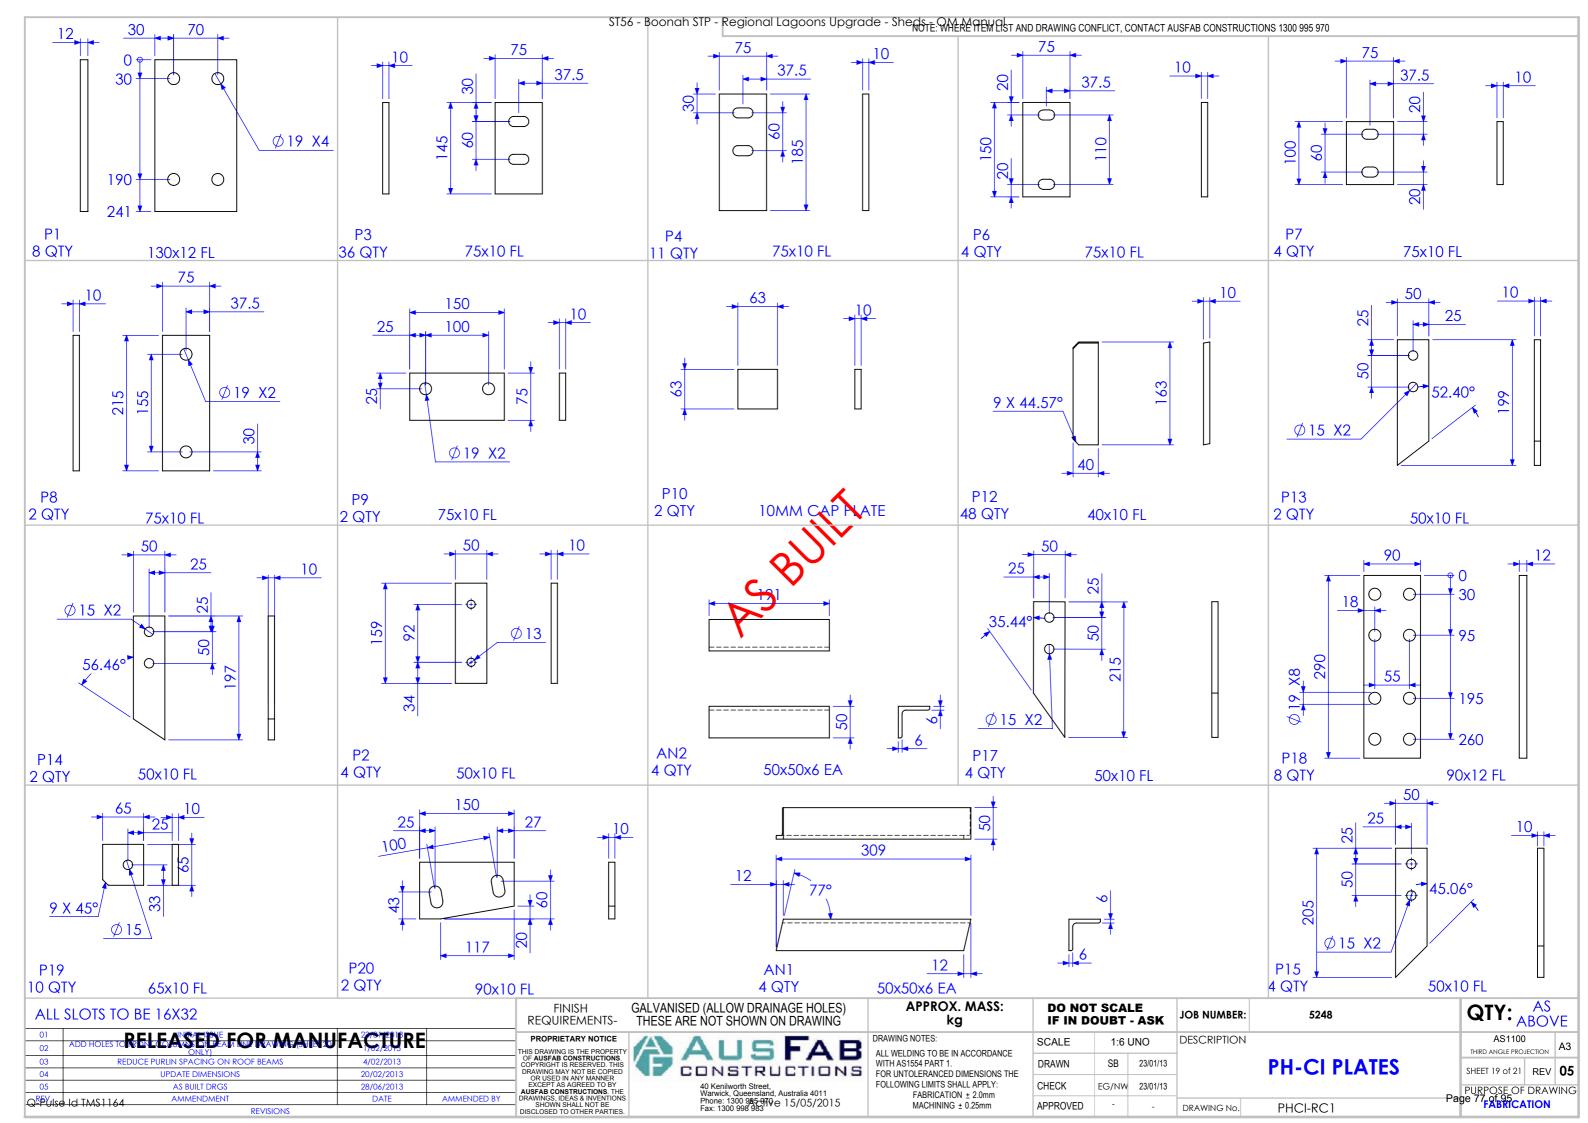

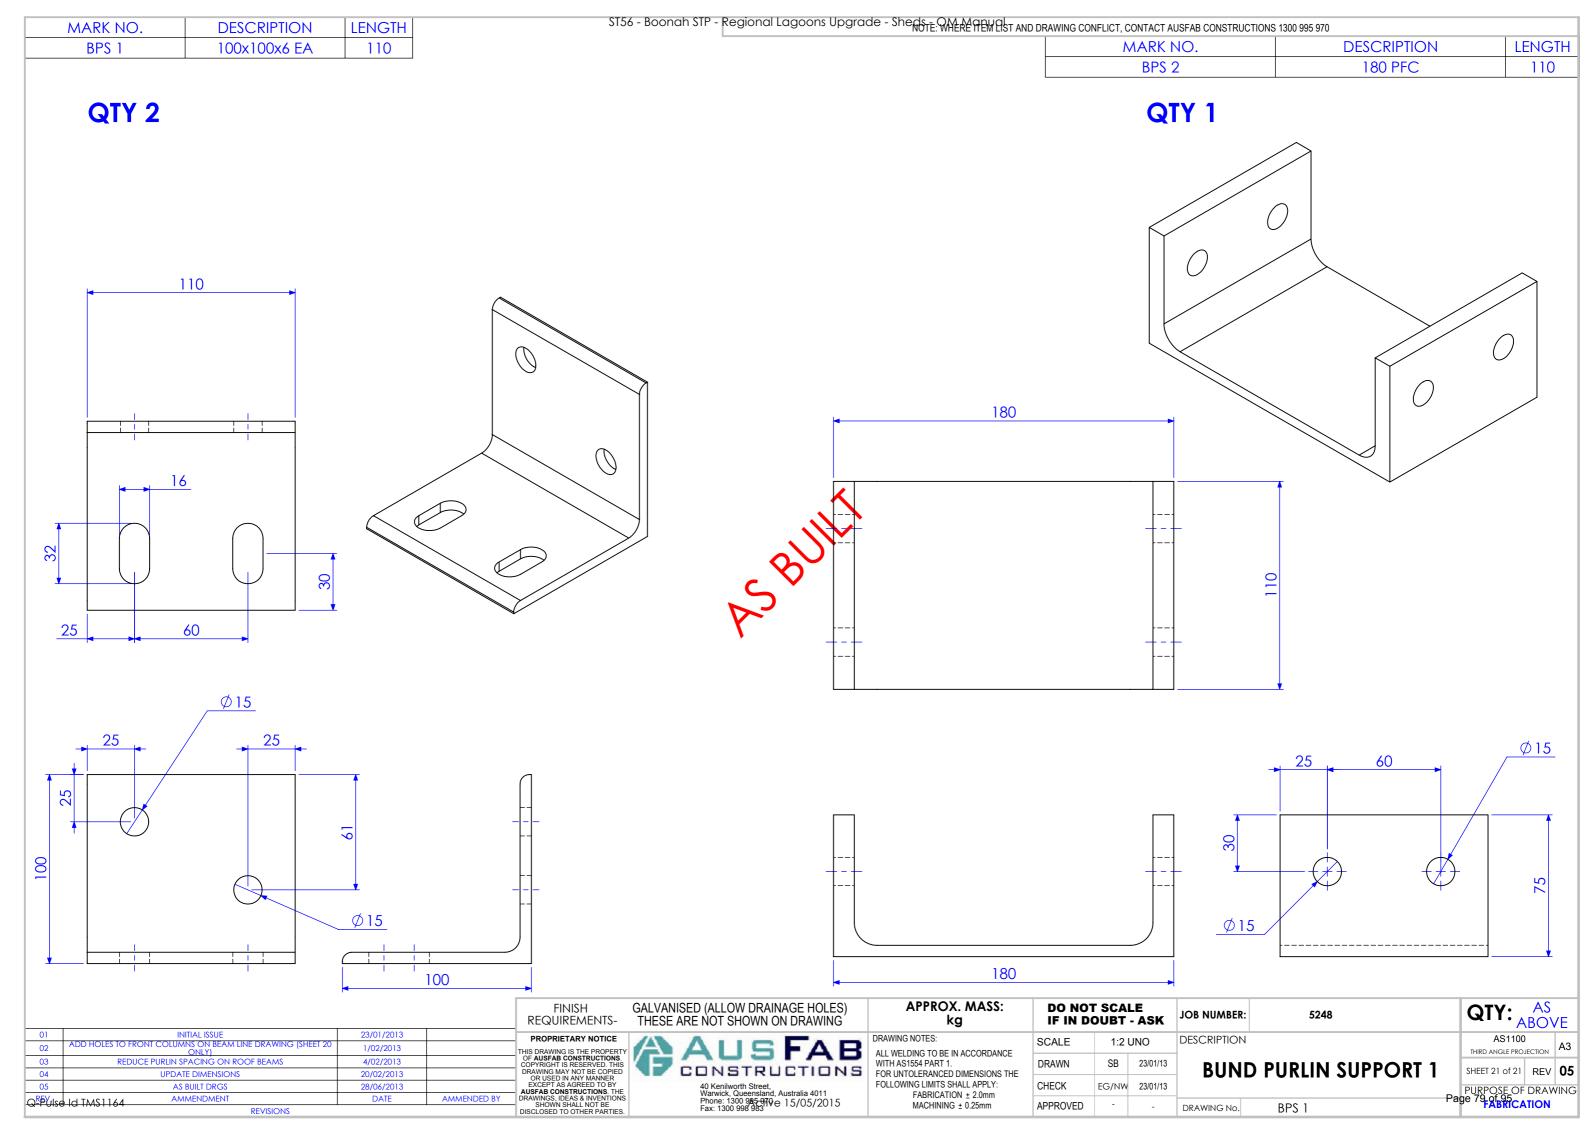

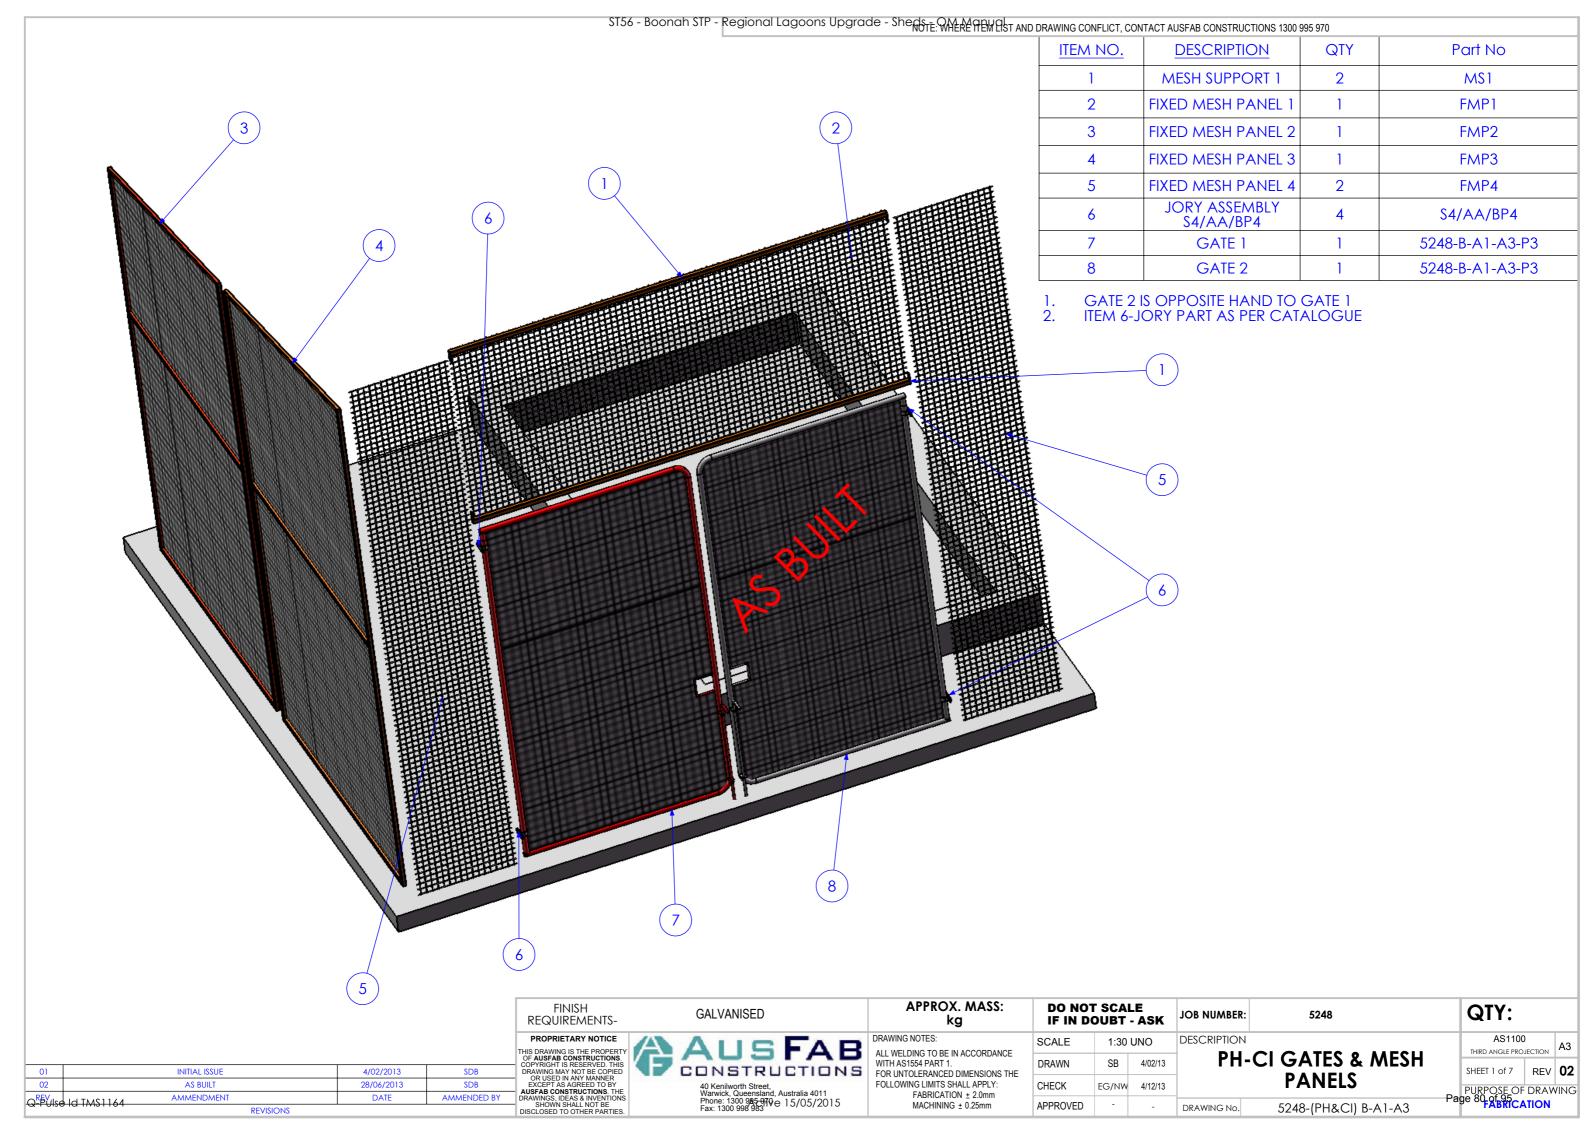


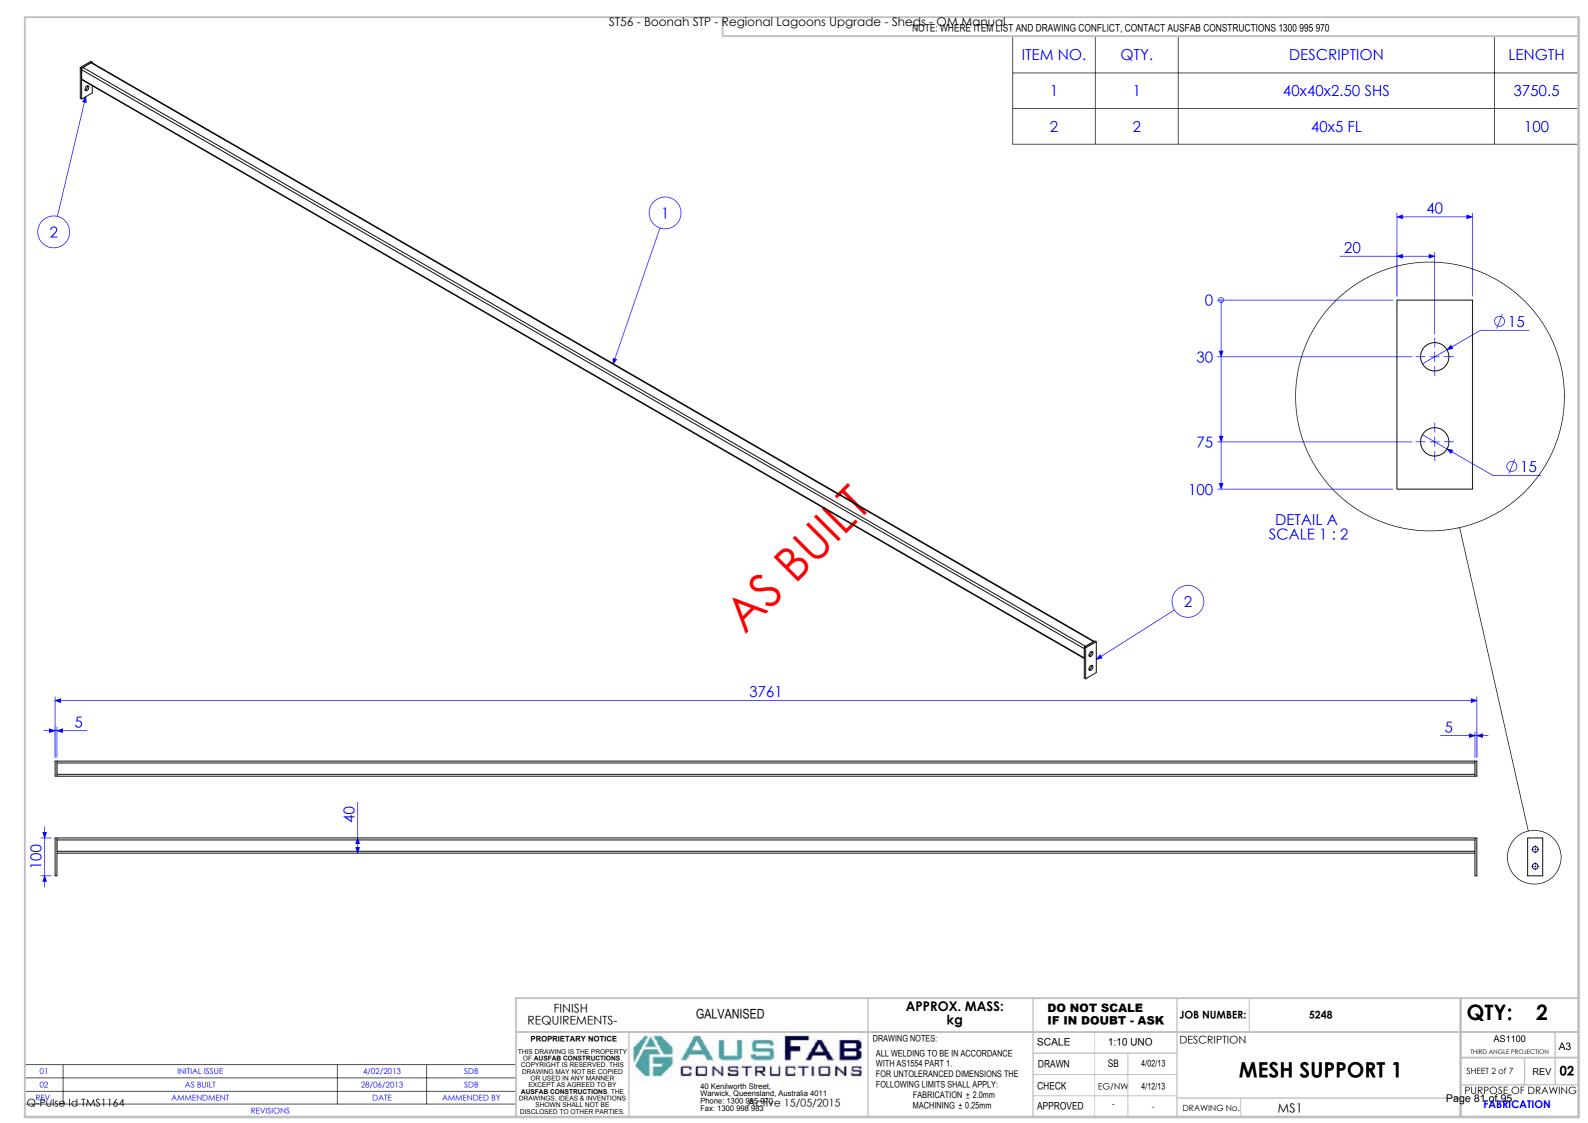


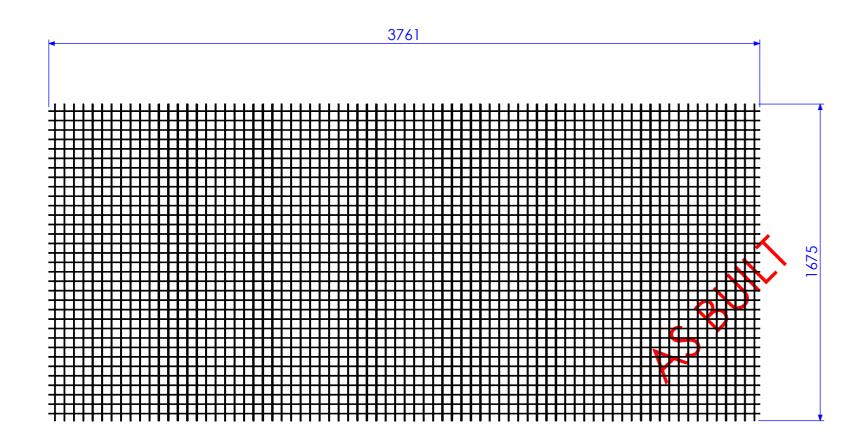



50X50X3 GALVANISED MESH REQUIREMENT TO JOIN AT 3000 MARK



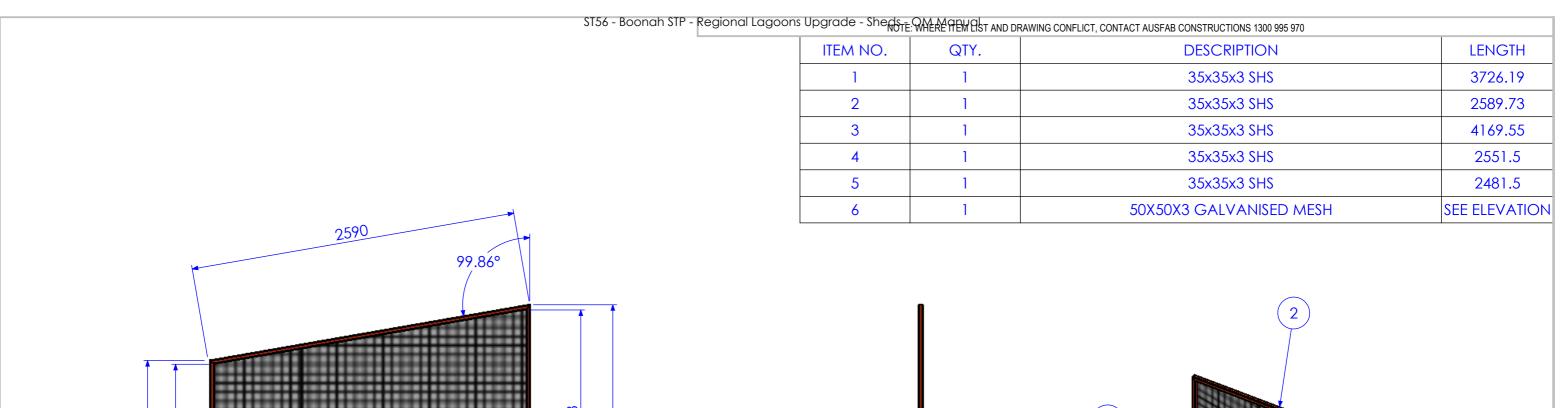

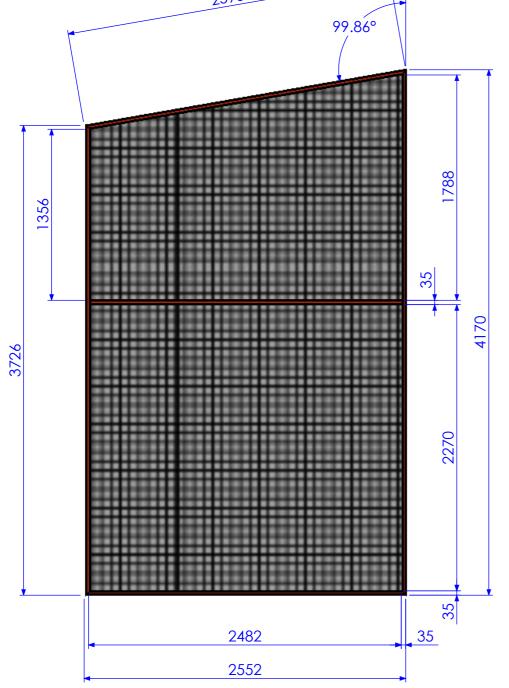

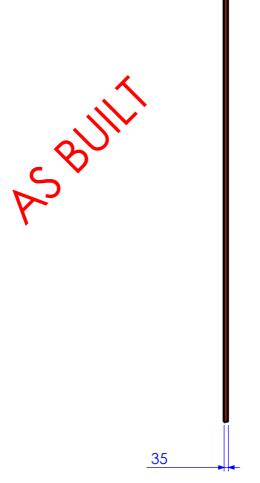

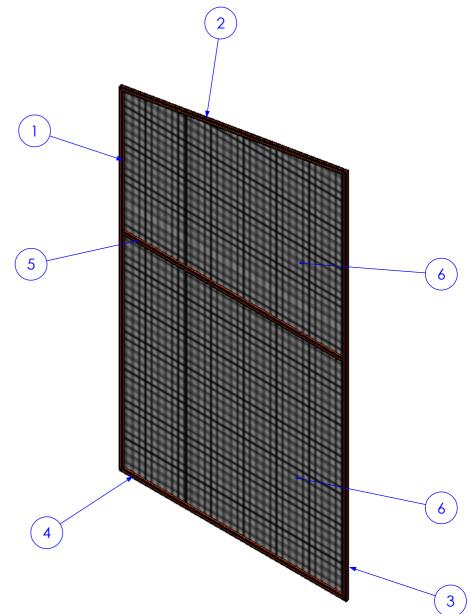

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01	INITIAL ISSUE	4/02/2013	SDB
02	AS BUILT	28/06/2013	SDB
O.REV ilse	e Id TMS1164 AMMENDMENT	DATE	AMMENDED BY
Q-1 0130	REVIS	SIONS	•

REQUIREMENTS-	GALVANISED
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DRAWING NOTES:
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WITH AS1554 PART 1.
FOR UNTOLERANCED DIMENSIONS THE
FOLLOWING LIMITS SHALL APPLY:
FABRICATION ± 2.0mm
MACHINING + 0.25mm


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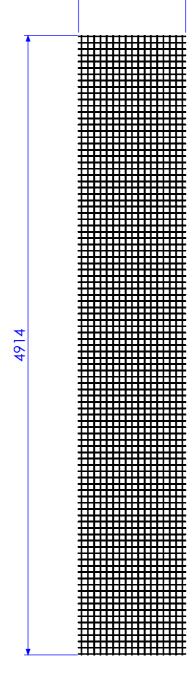
SCALE	1:30	UNO	DESCRIPTION
DRAWN	SB	4/02/13	FIX
CHECK	EG/NW	4/12/13	117
APPROVED	-	-	DRAWING No.

DRAWN SB 4/02/13			JOB NUMBER:	5248		(
SCALE	1:30	UNO	DESCRIPTION			TH
DRAWN	SB	4/02/13	FIX	ED MESH PANEL 2		SH
CHECK	EG/NW	4/12/13		LD MLOII I AIVEL 2		PL
			1		Par	nρ

FMP2

	QTY:	1	
	AS1100 THIRD ANGLE PRO	А3	
	SHEET 4 of 7	REV	02
Pa	PURPOSE OF ge 83-of 95 FABRICA	DRAW	/ING



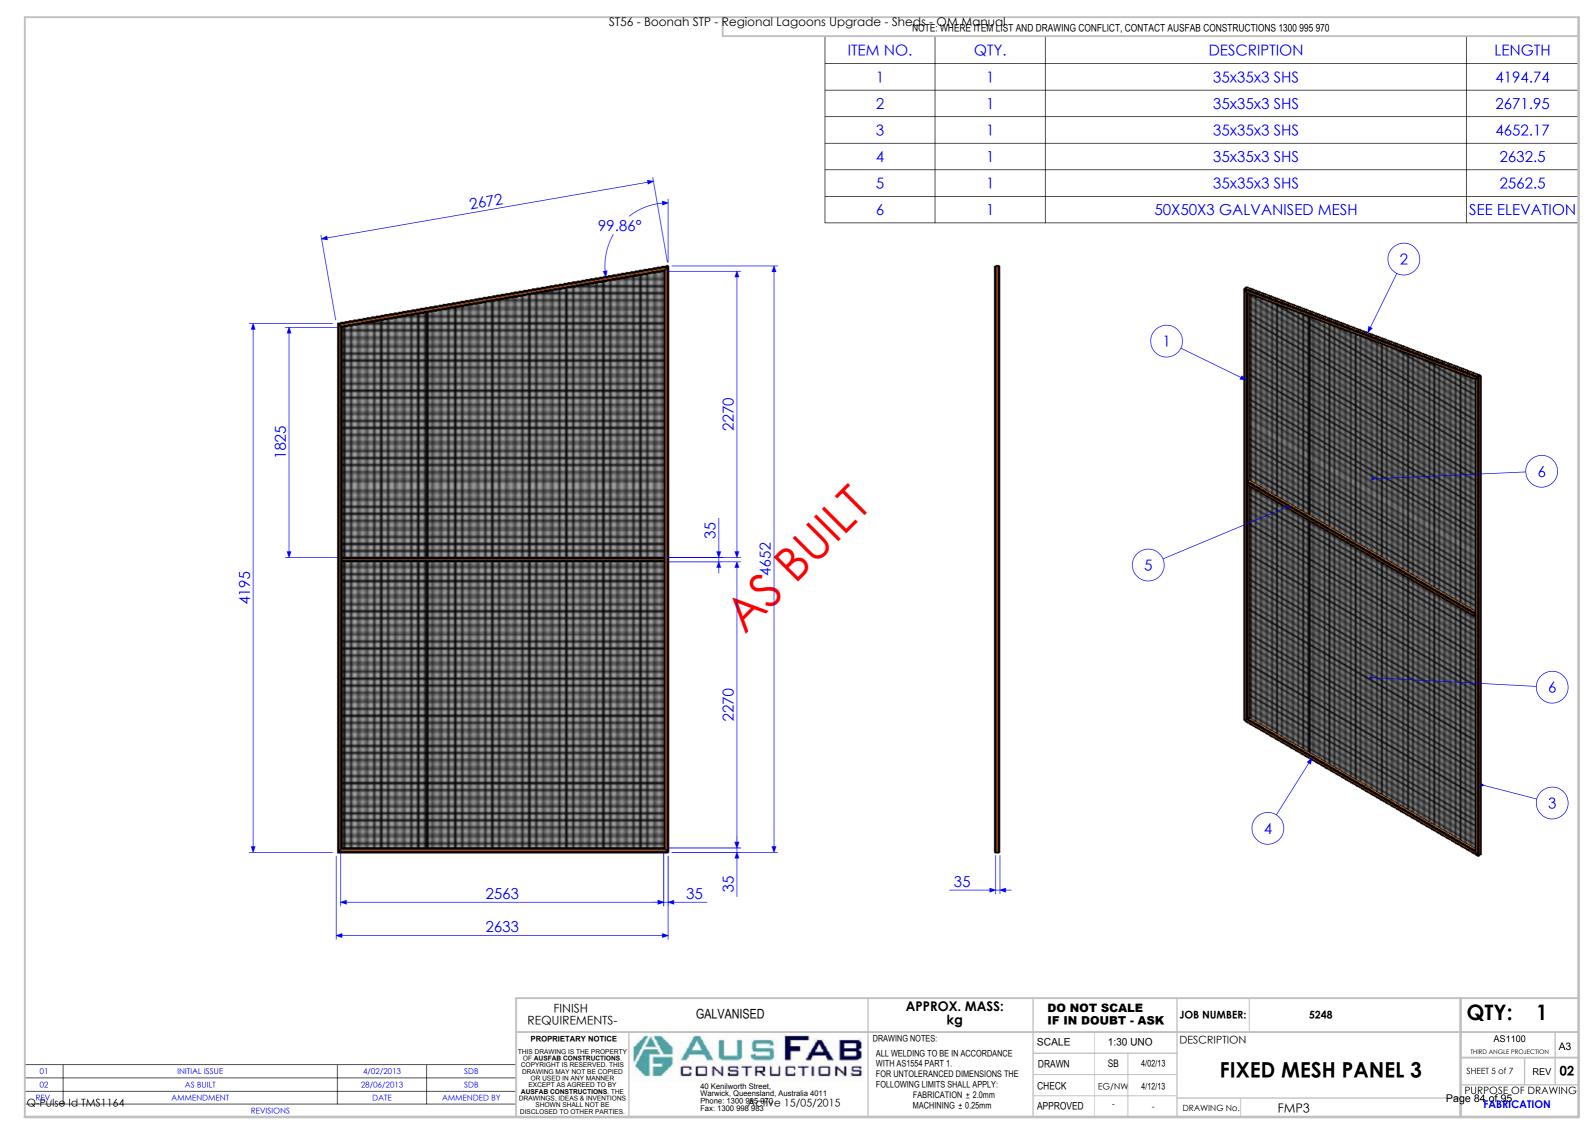



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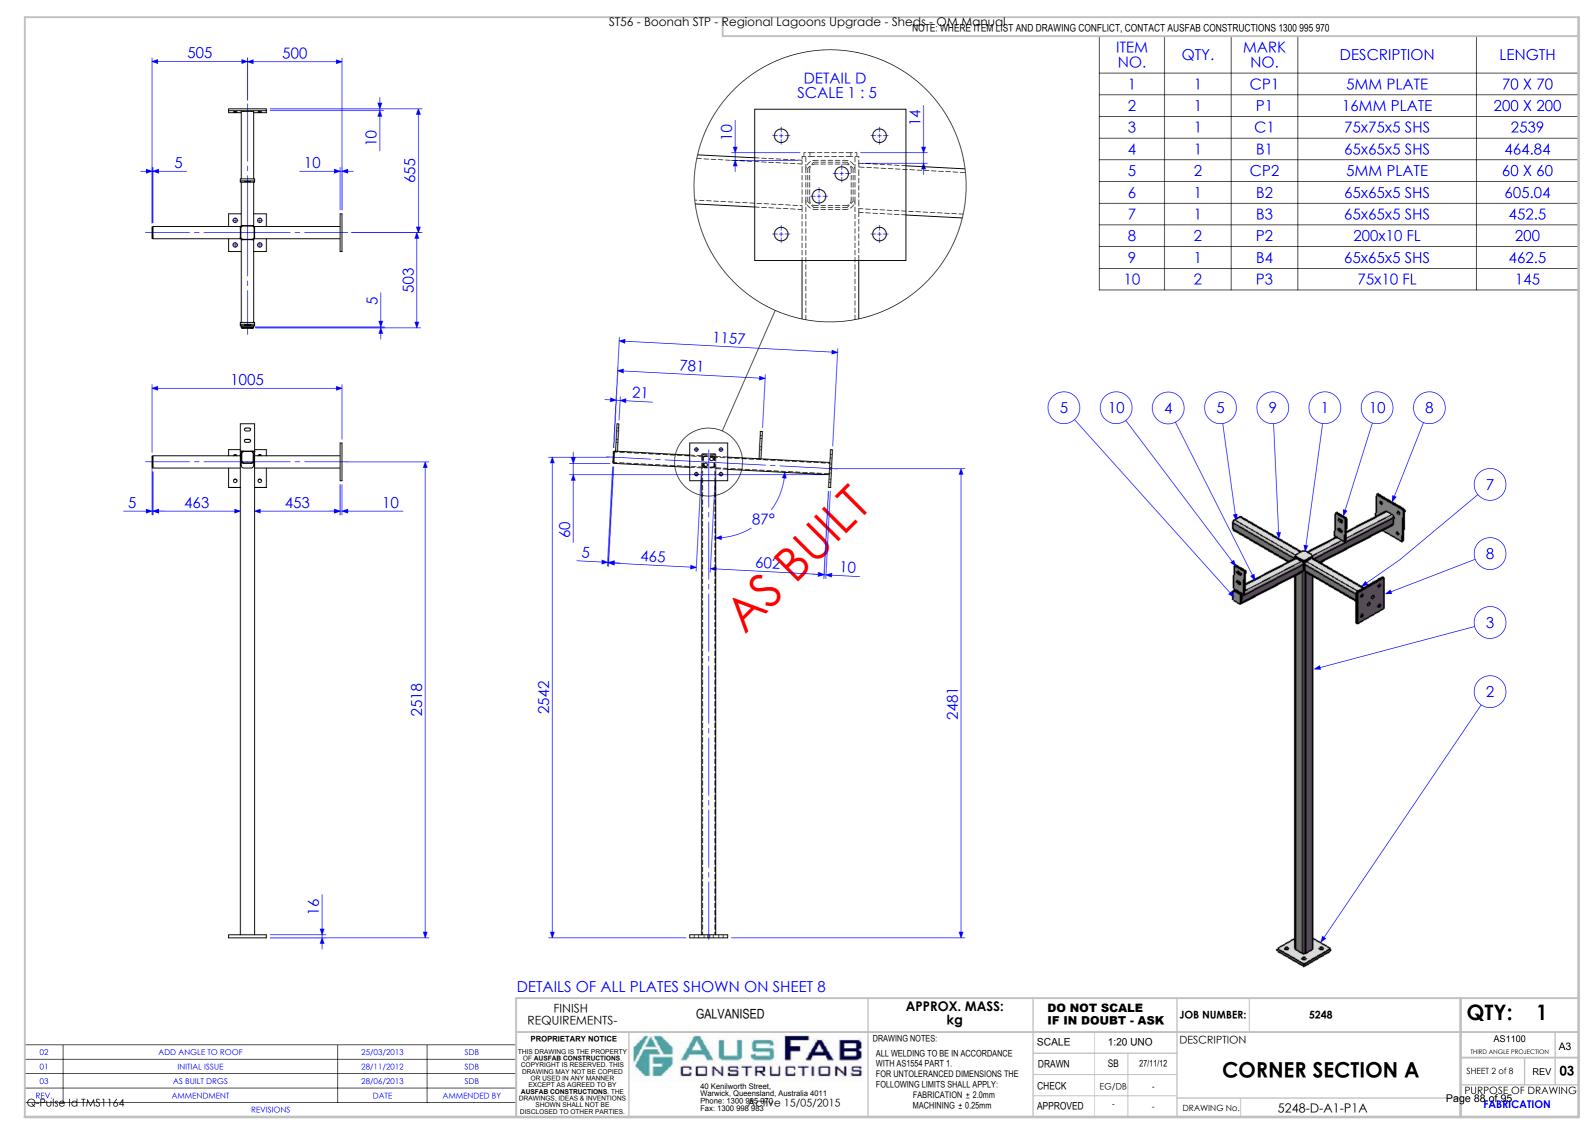
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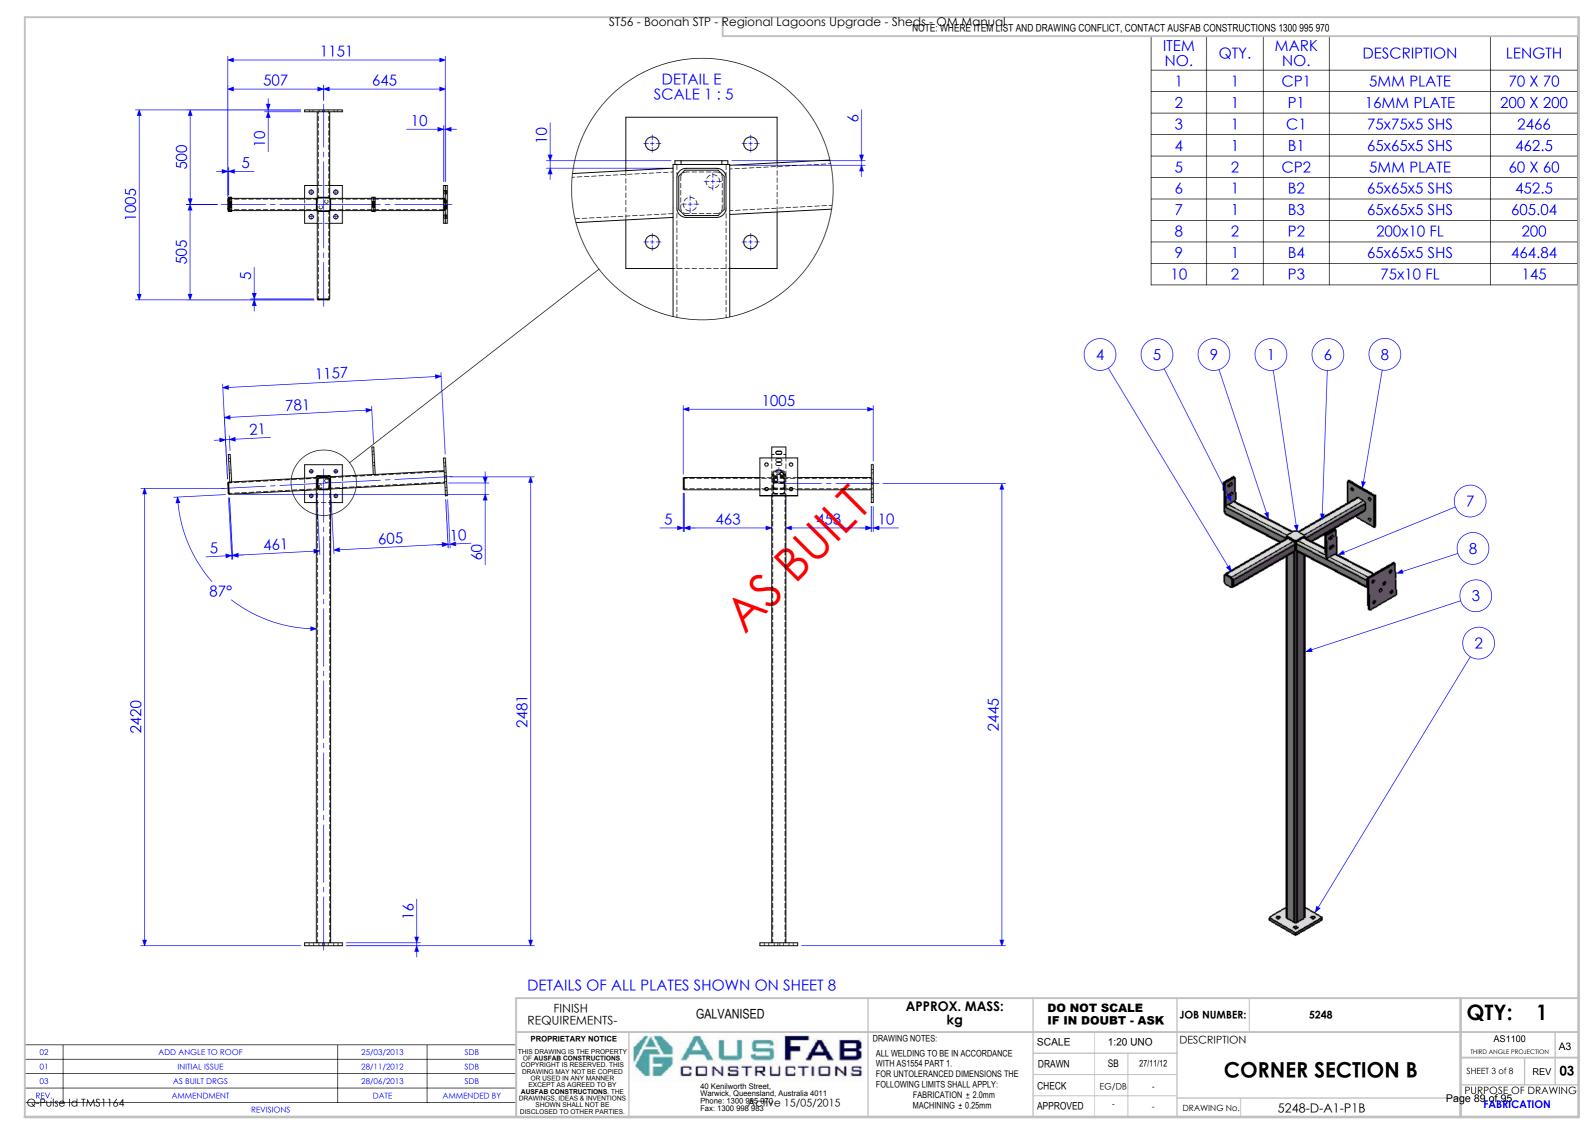
50X50X3 GALVANISED MESH REQUIREMENT TO JOIN AT 3000 MARK


				FINISH REQUIREMENTS-	GALVANISED	APPROX. MASS: kg		T SCALE OUBT - AS	JOB NUMBER:	5248	QTY:	2
				PROPRIETARY NOTICE THIS DRAWING IS THE PROPERTY	ALISEAR	DRAWING NOTES: ALL WELDING TO BE IN ACCORDANCE	SCALE	1:30 UNO	DESCRIPTION		AS11 THIRD ANGLE F	N 3
01	INITIAL ISSUE	4/02/2013	SDB	OF AUSFAB CONSTRUCTIONS. COPYRIGHT IS RESERVED. THIS DRAWING MAY NOT BE COPIED	CONSTRUCTIONS	WITH AC1554 DADT 1	DRAWN	SB 4/02	13 FIX	ED MESH PANEL 4		
02	AS BUILT	28/06/2013	SDB	OR USED IN ANY MANNER EXCEPT AS AGREED TO BY AUSFAB CONSTRUCTIONS. THE	40 Kenilworth Street, Warwick, Queensland, Australia 4011	FOLLOWING LIMITS SHALL APPLY:	CHECK	EG/NW 4/12			PURPOSE (OF DRAWING
Q ^P FVIse Id TMS1164	AMMENDMENT REVISIONS	DATE	AMMENDED BY	DRAWINGS, IDEAS & INVENTIONS SHOWN SHALL NOT BE DISCLOSED TO OTHER PARTIES.	Phone: 1300 985 970 e 15/05/2015 Fax: 1300 998 983	FABRICATION ± 2.0mm MACHINING ± 0.25mm	APPROVED		DRAWING No.	FMP4	Page 85 of 95	CATION







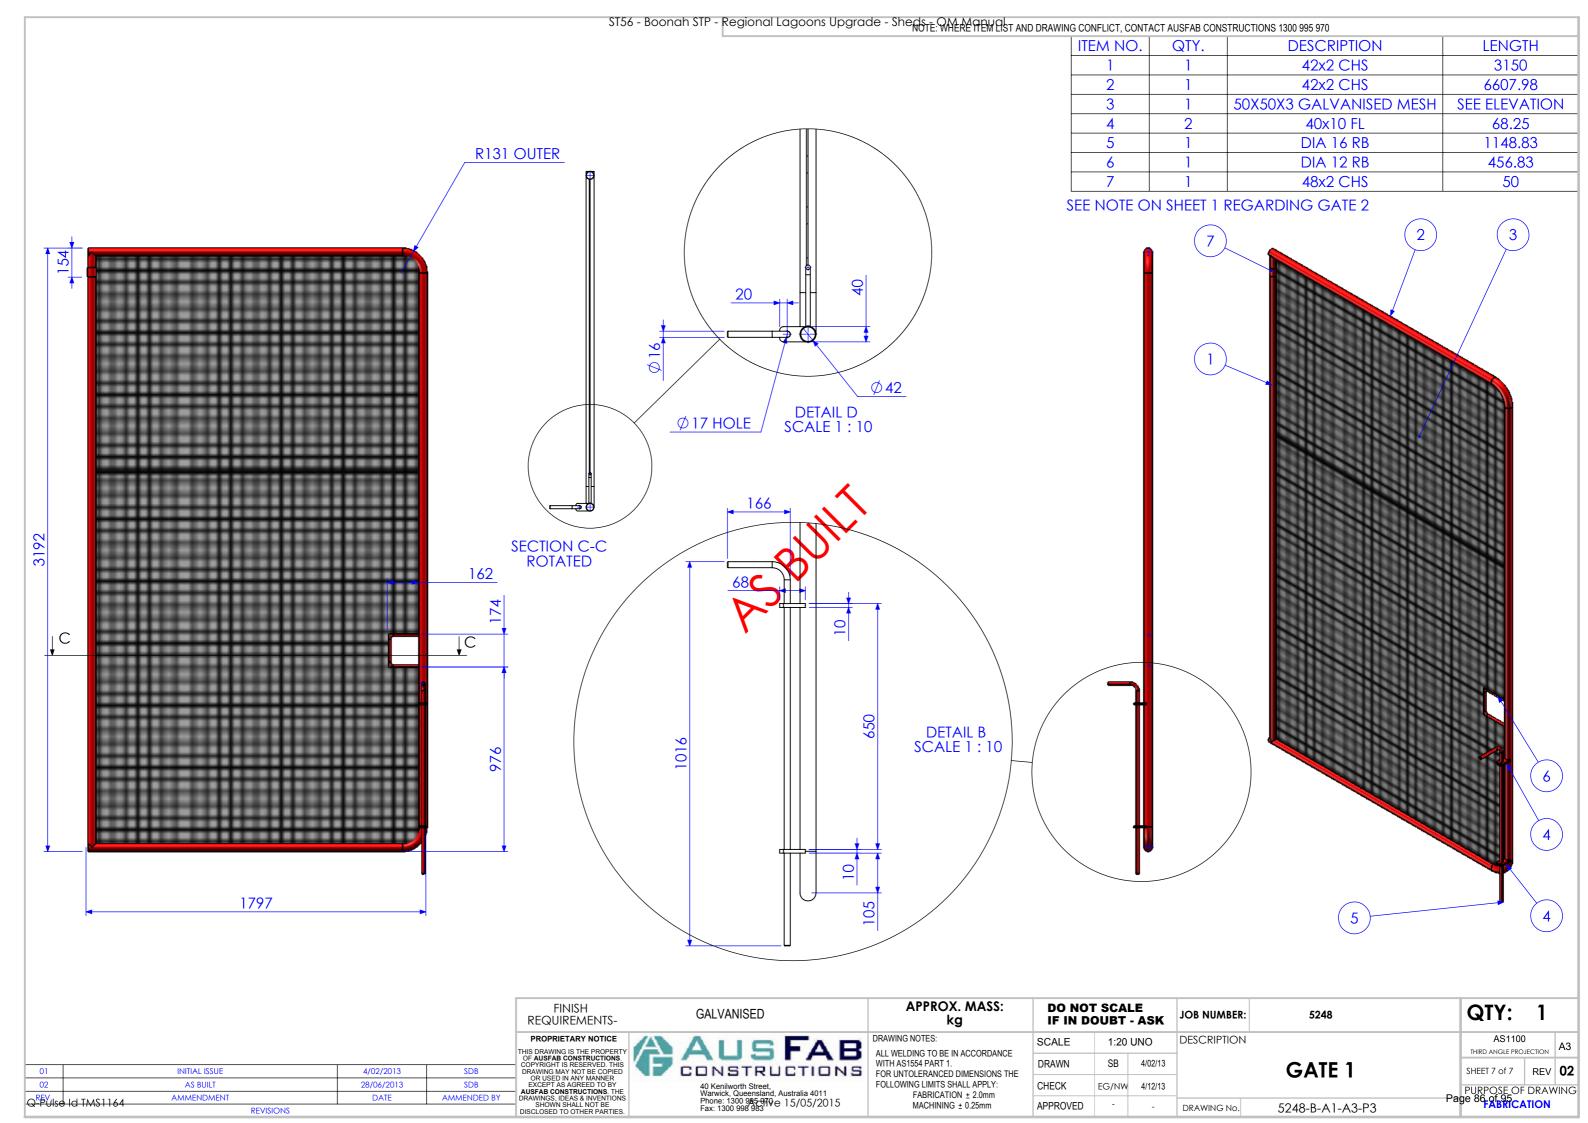

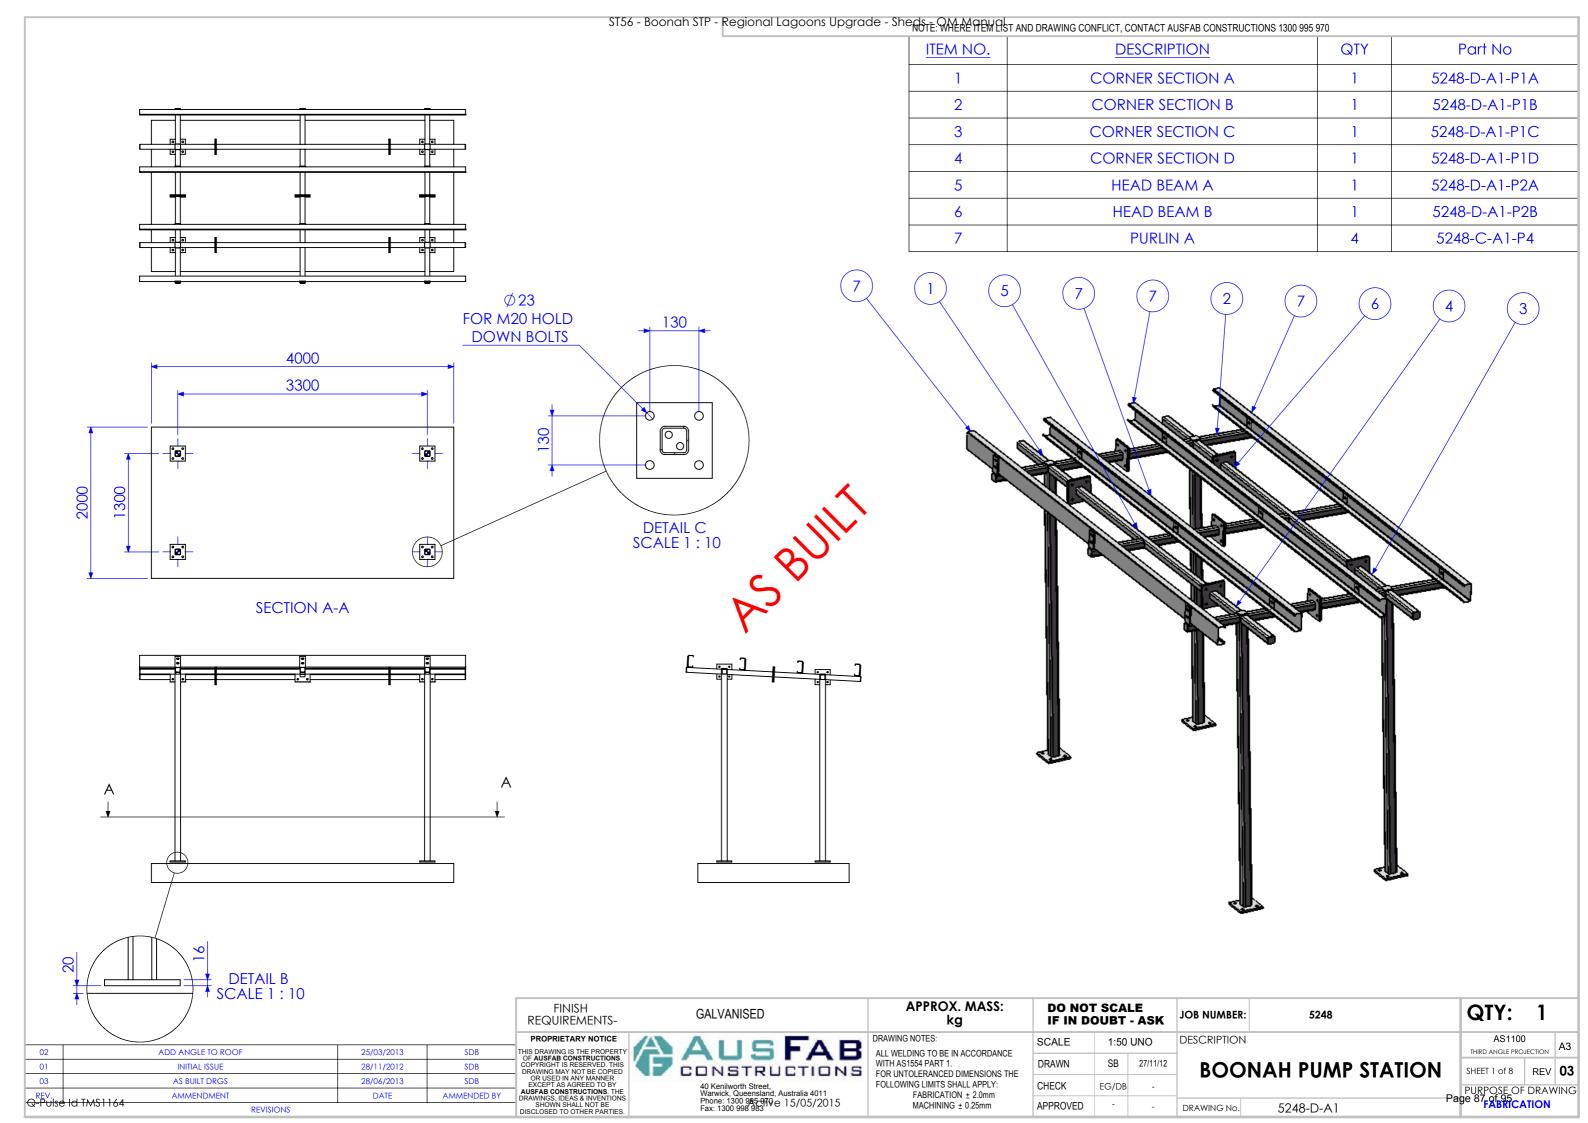


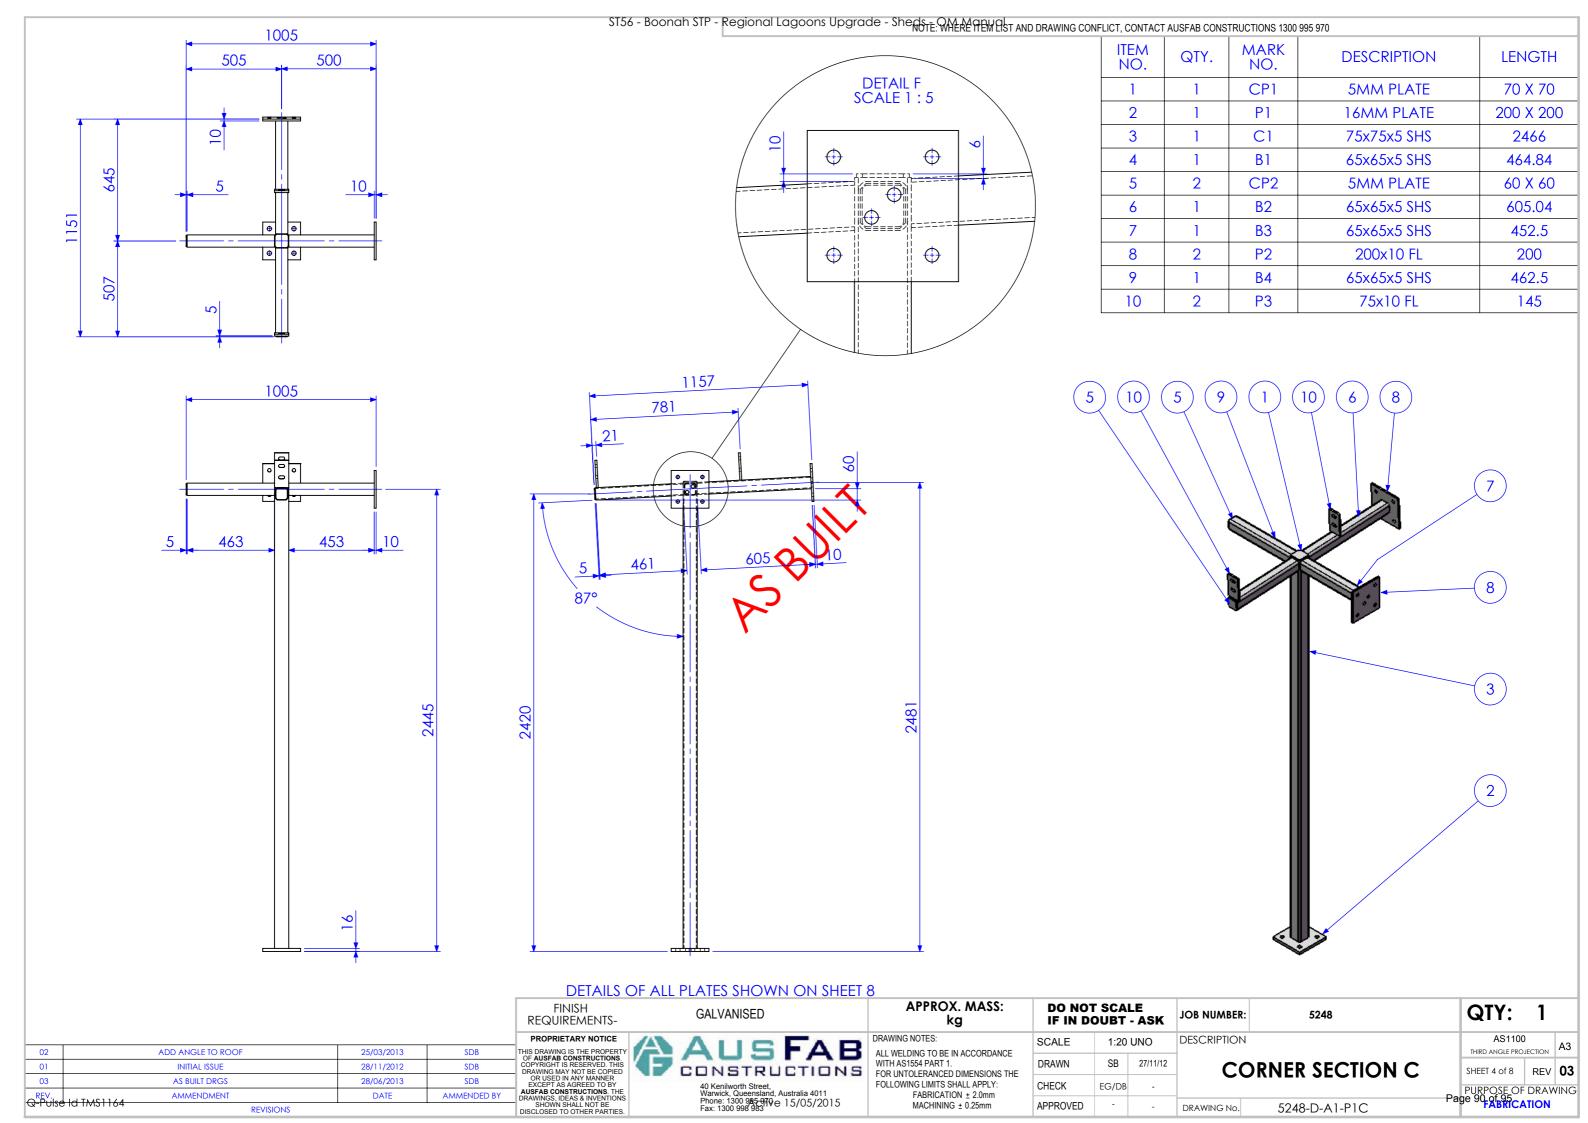

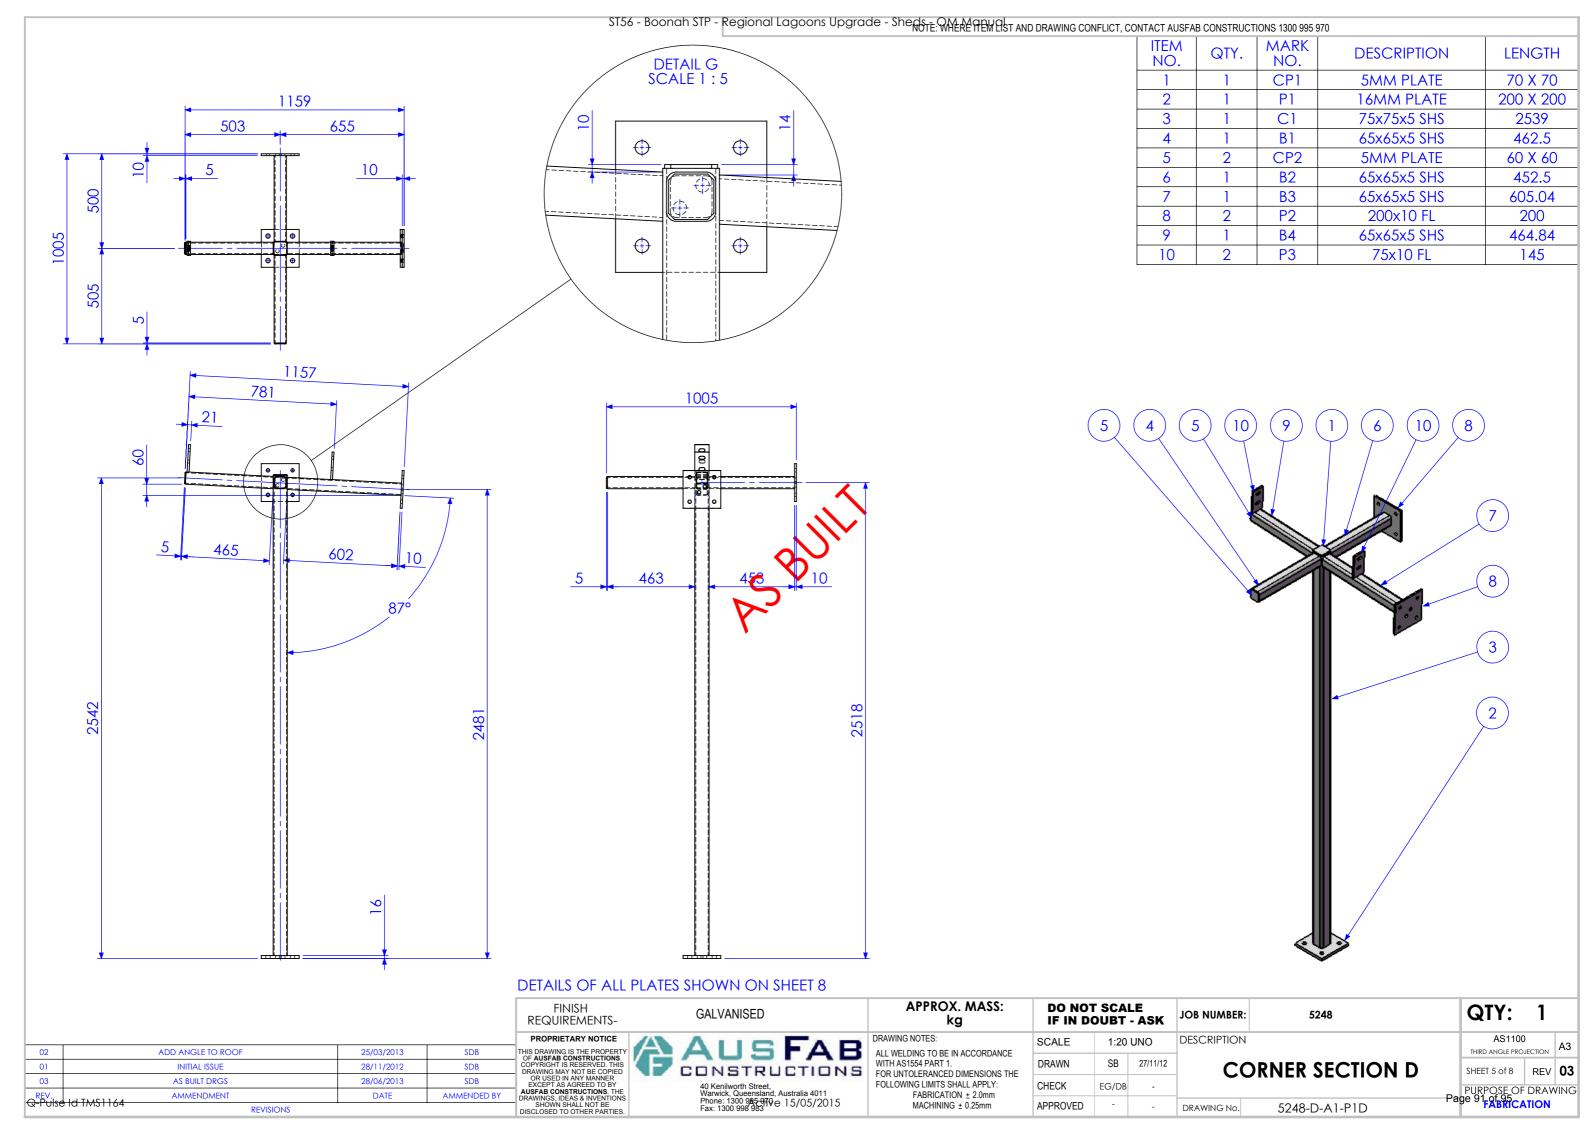

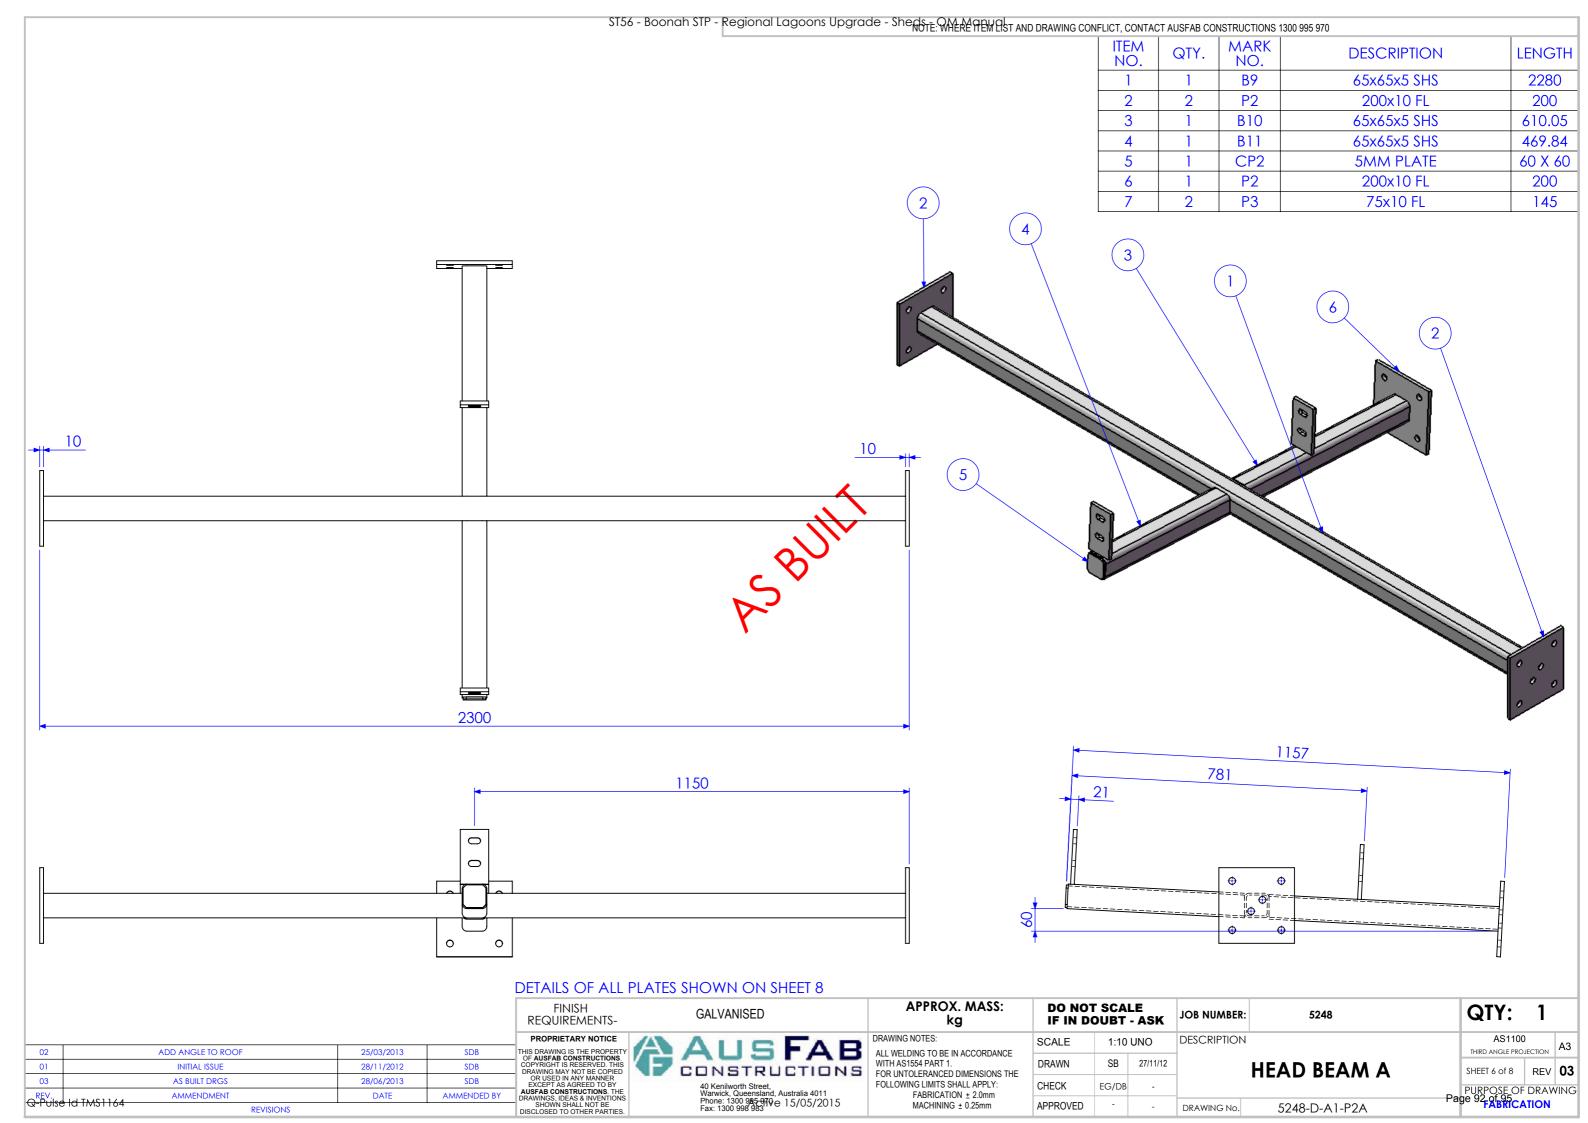


S156 - Boonan STP - Regional Lagoons Upgrade - Sheds - OM Manual AND D	RAWING CONFLICT, CONTACT AUSFAB CONSTRUCTIONS 1300 995 970	
	DESCRIPTION	LENGTH
	Lysaght_150cee	4310

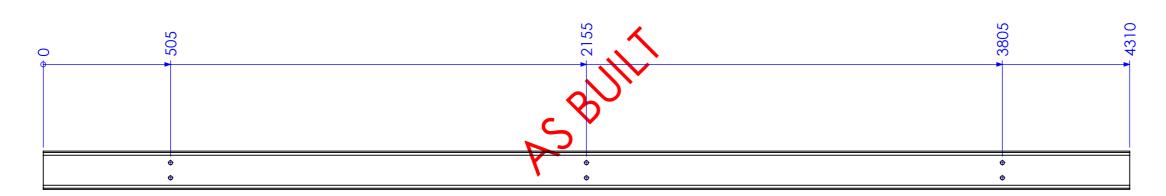


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SUPPLIED BY PURLIN MANUFACTURER

				FINISH REQUIREMENTS-	GALVANISED	APPROX. MASS: kg		T SCALE OUBT - ASK	JOB NUMBER:	5248		QTY:	4	
				PROPRIETARY NOTICE		DRAWING NOTES:	SCALE	1:15 UNO	DESCRIPTION			AS1100	1	۸2
02	ADD ANGLE TO ROOF	25/03/2013	SDB	THIS DRAWING IS THE PROPERTY OF AUSFAB CONSTRUCTIONS.	AUSFAB	ALL WELDING TO BE IN ACCORDANCE			_	PURLIN A		THIRD ANGLE PROJE	JECTION	AS
01	INITIAL ISSUE	28/11/2012	SDB	COPYRIGHT IS RESERVED. THIS DRAWING MAY NOT BE COPIED	CONSTRUCTIONS	I MITH AC1664 DADT 1	DRAWN	SB 27/11/12		PURLIN A		SHEET 7 of 8	REV	03
03	AS BUILT DRGS	28/06/2013	SDB	OR USED IN ANY MANNER EXCEPT AS AGREED TO BY	40 Kenilworth Street,	FOLLOWING LIMITS SHALL APPLY:	CHECK	EG/DB -						
REV.	AMMENDMENT	DATE	AMMENDED BY	AUSFAB CONSTRUCTIONS. THE DRAWINGS. IDEAS & INVENTIONS	Warwick, Queensland, Australia 4011	FABRICATION ± 2.0mm	OFFICER	LO/DD			Pag	PURPOSE OF I	DRAW	/ING
Q-Pulse	Id TMS1164 REVISIONS	1		SHOWN SHALL NOT BE DISCLOSED TO OTHER PARTIES.	Phone: 1300 985 970 e 15/05/2015 Fax: 1300 998 983	MACHINING ± 0.25mm	APPROVED	- -	DRAWING No.	5248-C-A1-P4	ı agı	FA'BRICAT	JION	



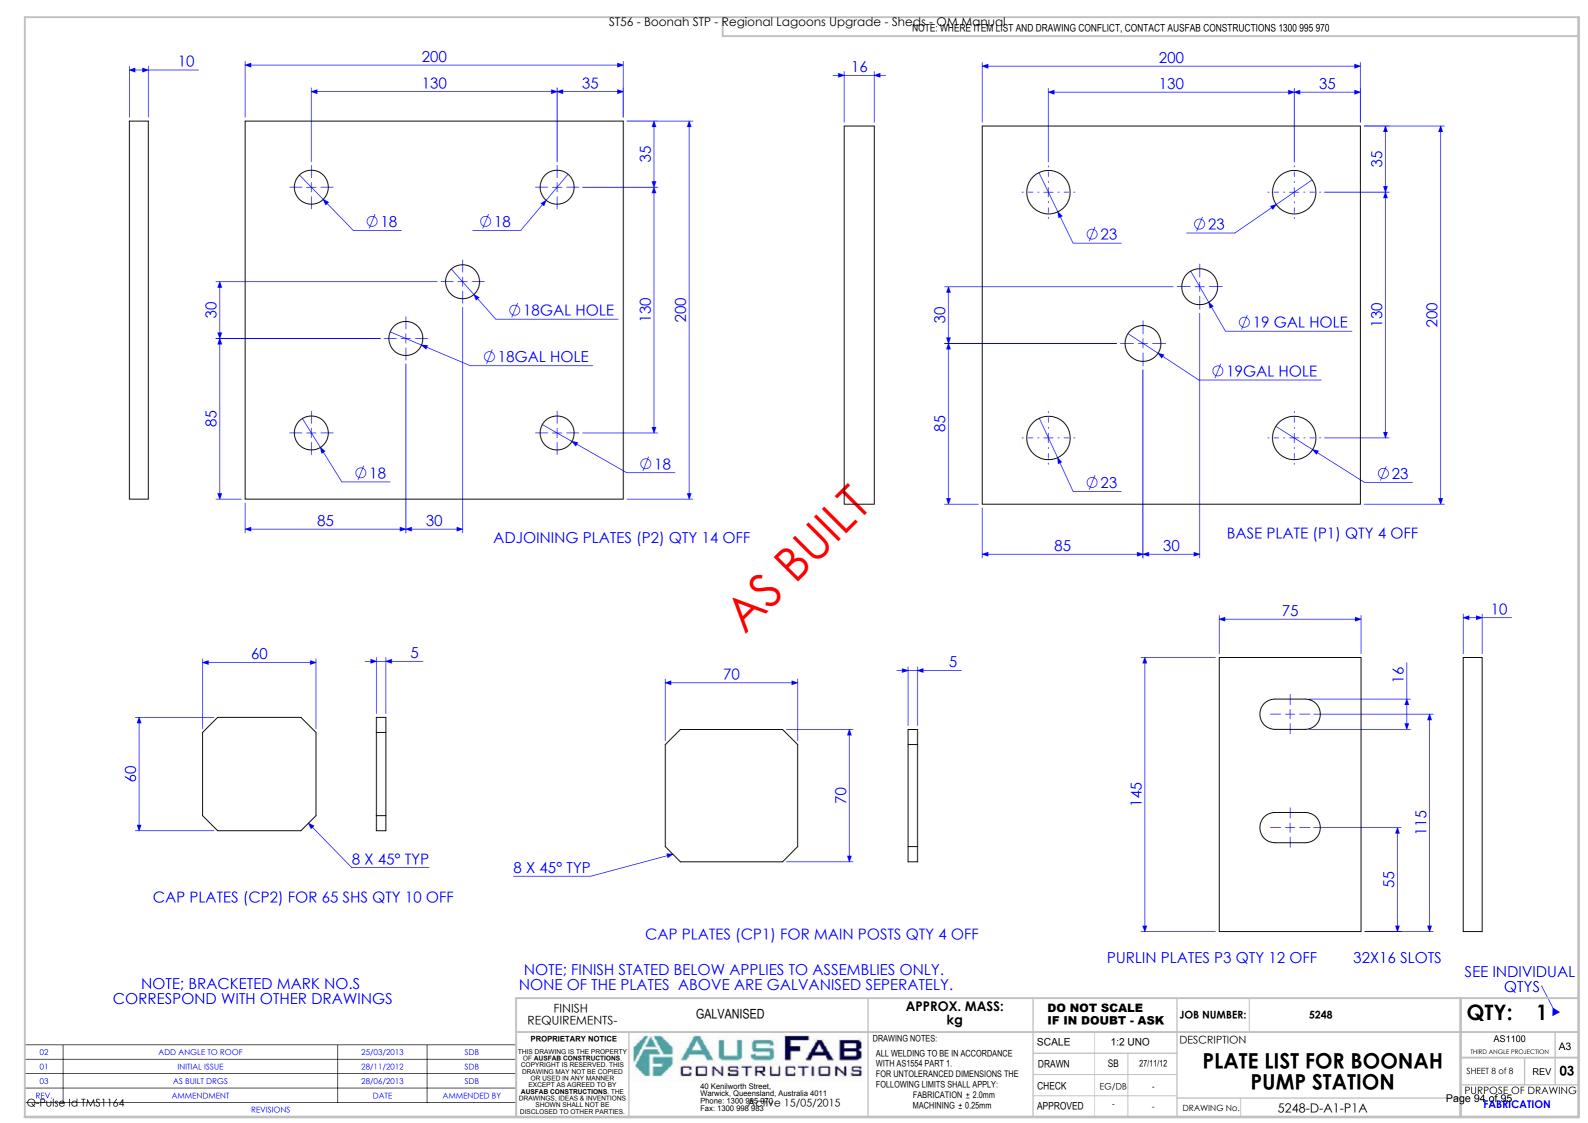

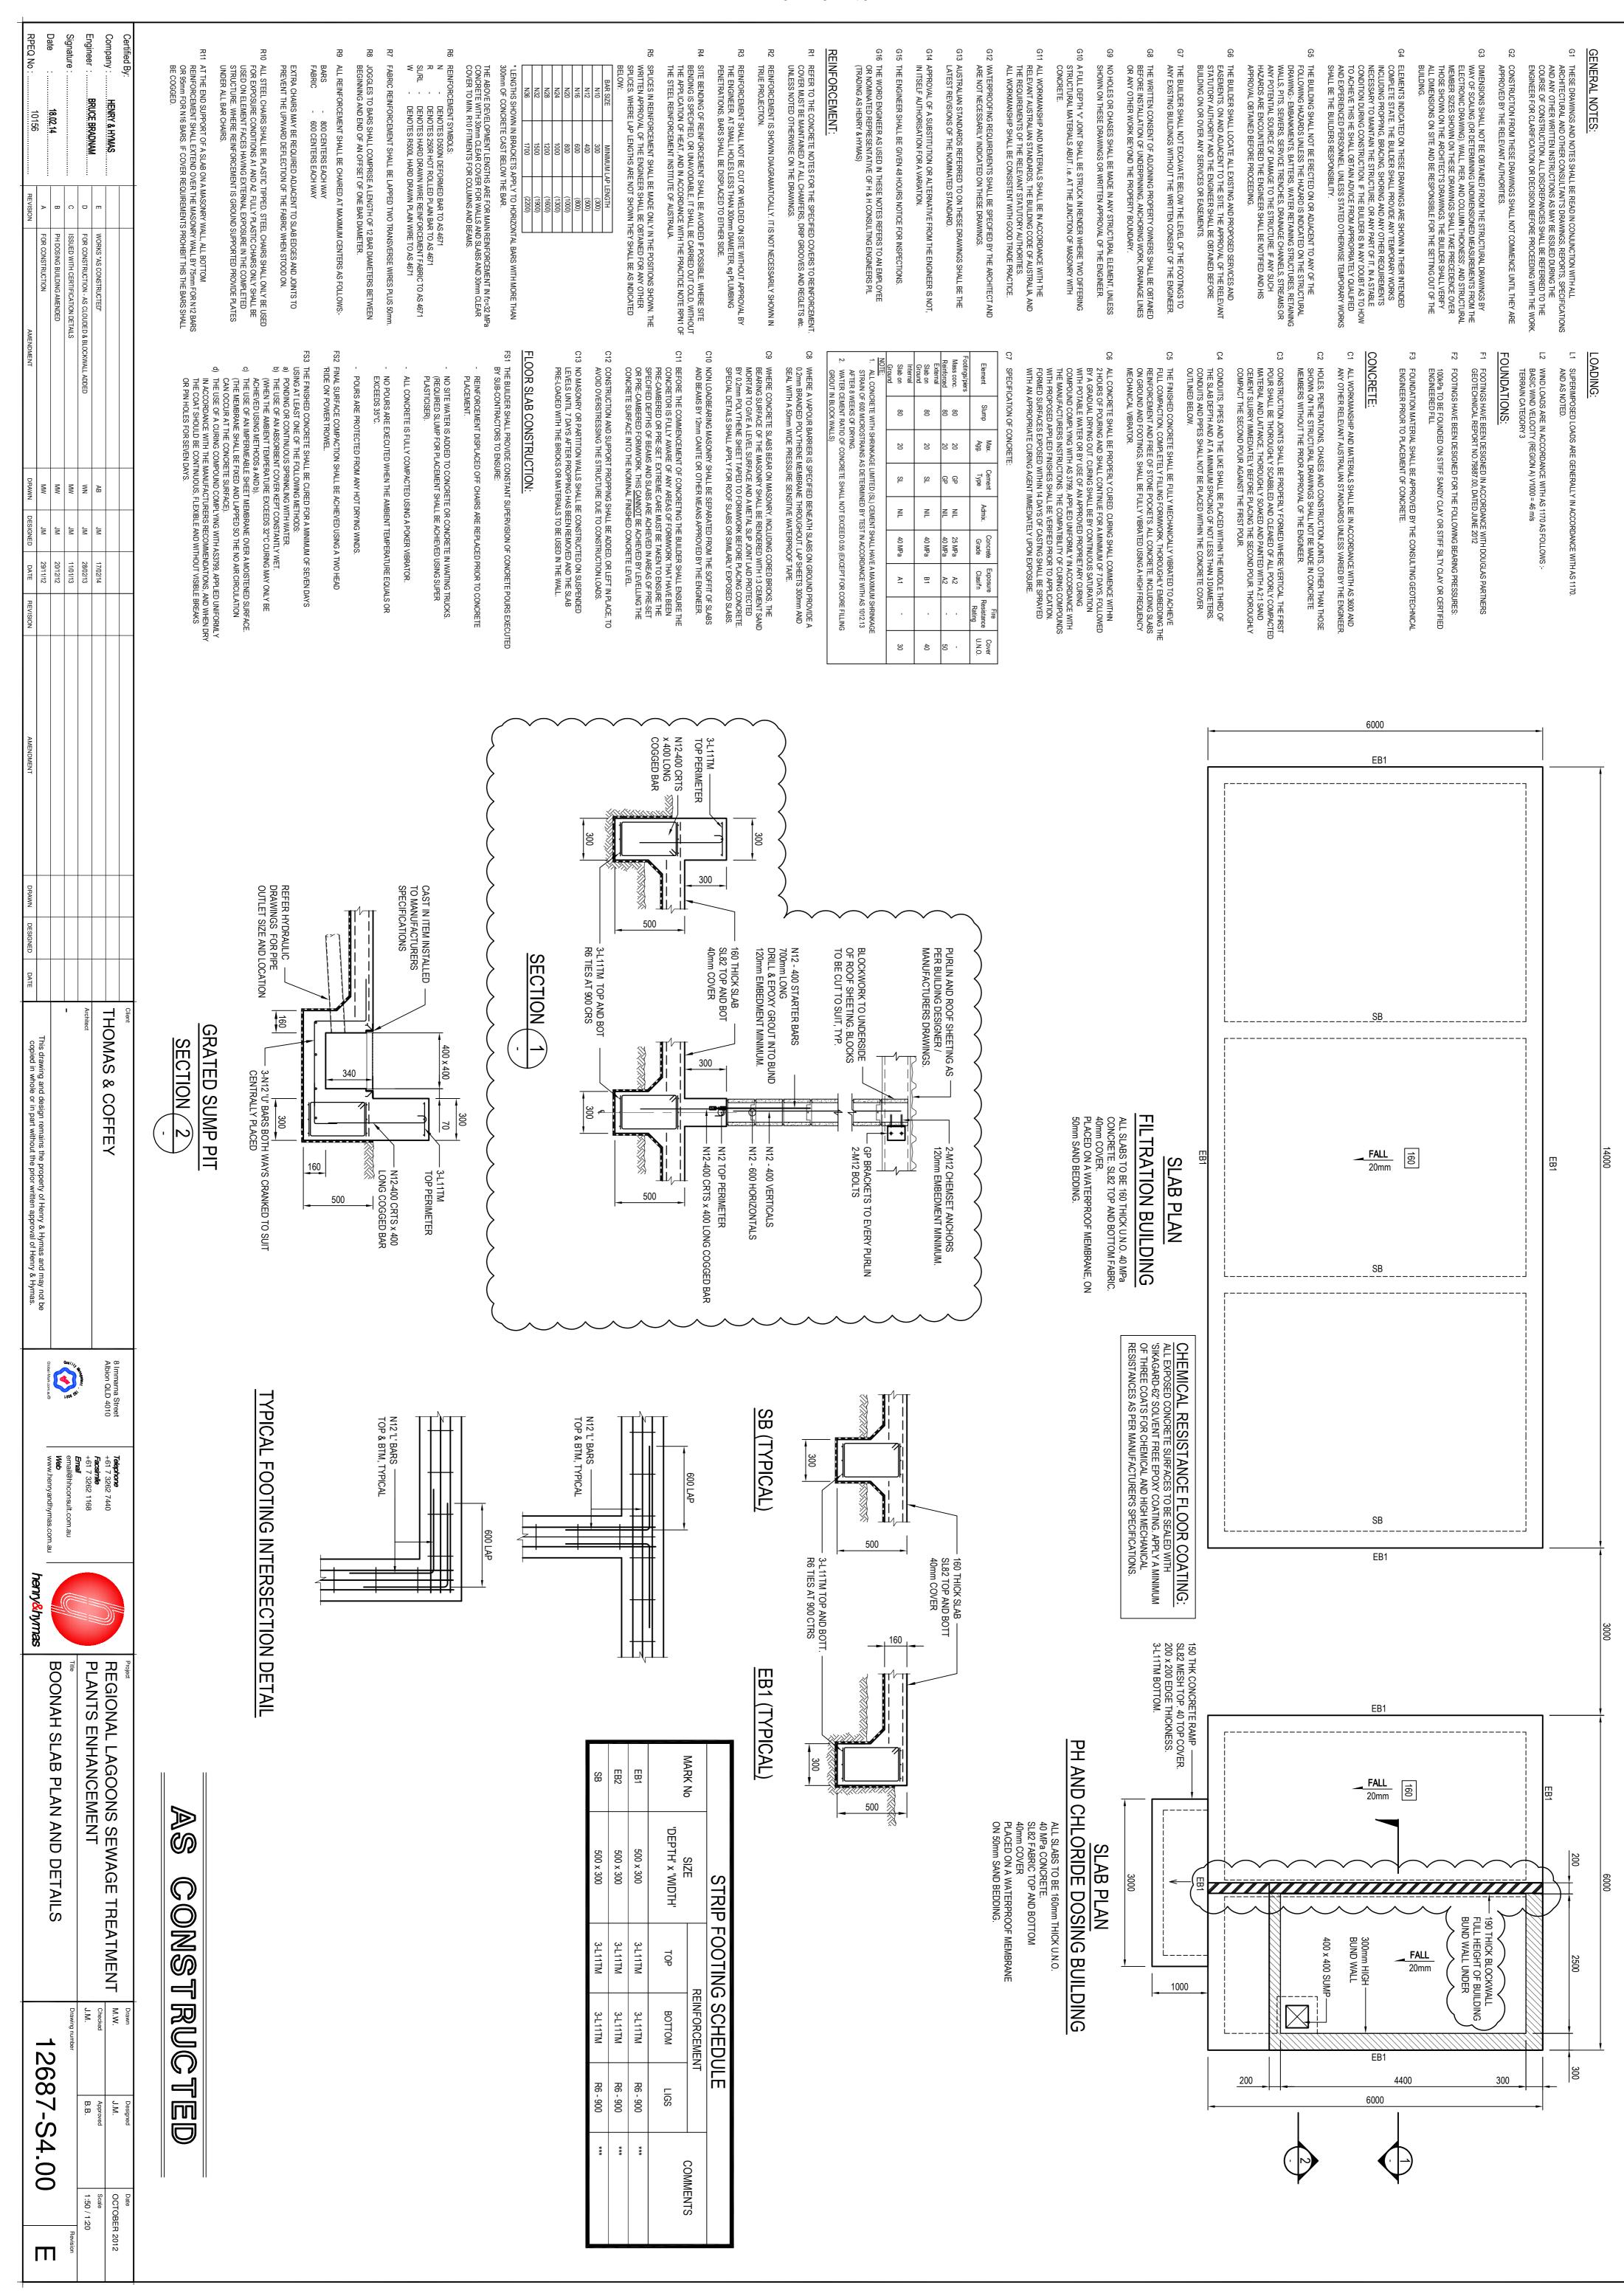Active 15/05/2015